

Head Office, Airport North Road
P.O. Box 19001 - 00501 Nairobi, Kenya

Tel: +254 - 020 - 822111 / 6611000 / 6612000 Fax: +254 - 020 - 822078, 827304

Email: info@kaa.go.ke www.kaa.go.ke

KAA/OT/NAROK/010572024-2025

11th March, 2025

To: All Bidders

RE: PROPOSED RUNWAY CONSTRUCTION WORKS AT NAROK AIRSTRIP

TENDER NO. KAA/OT/NAROK/0105/2024-2025

ADDENDUM NO. 1

The following are tender clarifications/addendum issued regarding the above tender in accordance to instructions to tenderers of the bidding document.

	Response
Having gone through the tender document for the above mentioned tender, we firmly believe the works could be manageable to completion by a NCA 2 Civil Works registered company.	Bidders are hereby informed that NCA 2 and above registration for Civil and Road works shall be applicable.
We would like to request the procuring entity to include NCA 2 Civil Works registered companies for tendering eligibility for the above mentioned tender.	
Under technical evaluation criteria No. 2 Equipment and Machinery Must demonstrate availability of the following key minimum equipment necessary to undertake the work. The equipment must be serviceable and in good working condition. 2 No. Motor Grader - (CAT 140H or equivalent) 2 No. Water Bowser - (≥8,000 Lts) 15 No. Tipper trucks -≥15 Tonnes 2 No. Pneumatic Tyred Roller -≥8 Tonnes (for AC works) 2 No. Vibrating Drum Roller -≥8 Tonnes 1 No. Pressure bitumen distributor -≥ 8,000 Litres 1 No. AC Paver. 1No. Asphalt Plant (production 30-120 Tonnes/hr) 1No. Self-propelled pulvimixer 1 No sheep foot roller	Equipment and Machinery Must demonstrate availability of the following key minimum equipment necessary to undertake the work. The equipment must be serviceable and in good working condition. a) 2 No. Motor Grader - (CAT 140H or equivalent) b) 3 No. Water Bowser - (≥8,000 Lts) c) 10 No. Tipper trucks -≥15 Tonnes d) 1 No. Pneumatic Tyred Roller - ≥15 Tonnes (for AC works) e) 2 No. Vibrating Drum Roller -≥16 Tonnes f) 1 No. Pressure bitumen distributor -≥ 4,500 Litres g) 1 No. AC Paver with automatic level sensors. h) 1No. Self-propelled pulvimixer i) 1 No sheep foot roller

	1 No. Wheel Loader - CAT 950G or	j) 1 No. Wheel Loader – CAT 950G
	equivalent	or equivalent
- 1	2 No. Excavator	k) 2 No. Excavator $- \ge 25$ Tonnes
	Notes	1 No.Excavator with rock breaker
	The equipment must be owned, must	attachment
	provide CLEAR copies of log book or proof	m) 1 No. Bulldozer-(D6 or equivalent)
	of ownership;	n) 1 No. Concrete cutter
		o) 1 .No. High precision pavement
		marking machine
		p) 1 No. Fuel Dumping (Bowser)
		truck
		q) 1. No. Double Cabin Pickup
		Generator for powering the
		Resident Engineers site office and
(security lighting on site during
		nighttime.
	·	Notes
		• If the equipment is owned, must provide CLEAR copies of log book
		or proof of ownership;
		If equipment is hired or leased
		Provide a commitment letter from
		the lessor of the equipment
		addressed to the Managing
		Director/CEO Kenya Airports
		Authority indicating that the lessor
		shall avail the equipment upon
		award of the tender and submit a copy of a written agreement to lease
		between lessee and lessor indicating
		list of equipment and their
11		corresponding copies of log books
	*	or proof of ownership by lessor;
	·	The equipment listed shall be
		available on site when required.
3.	Pursuant to Clause 14.2.1 of the Special	Bidders are hereby informed that Advance
*	Conditions of Contract, the bidder is	payment is not applicable.
G G	required to submit an Advance Payment Guarantee while according to Clause 14.2 of	
	the Special Conditions of Contract, the	
	Advance Payment is not applicable. Please	
	clarify.	
4.	In the Appendix to Tender, it is stated that	Bidders are hereby notified that the correct
	the time for completion is Twelve (15)	Time for completion is Twelve (12) months
	Months. Please clarify the correct position.	
5.	Drawings have not been appended to the	Bidders are hereby notified that the
	tender document as contemplated under	Drawings are herewith uploaded as appendix
	Section VII. We are requesting to know	
	when these drawings shall be availed.	

6.	We write to enquire of the prospected borrow areas, quarries and water points as we appreciate that gravels, rocks and water form key components of the project scope	Bidders are hereby informed that it is the responsibility of the bidder/contractor to search and identify sources of all construction materials and construction
	Torm key components of the project scope	water
7.	Change of BoQ	Bidders are hereby informed that the original
	ž.	BoQ which was sert out with the tender
		document is hereby expunged and replaced
		in its entirety with annexed BoQ

The closing/opening date is remains on 13th March,2025 at 11.00 a.m.

Kindly ensure your tender is valid for a period of 186 days and your tender security is valid for a period of 216 days from New closing/opening date of 13th March 2025 at 11.00. a. m.

This addendum forms part of the bidding document and is binding on all bidders. All other conditions remain the same.

Vincent Korir

GM (PROCUREMENT AND LOGISTICS)

For: MANAGING DIRECTOR/CEO

em

BILLS OF QUANTITIES

	PROPOSED RUNWAY CONSTRUCTION WORKS AT NAROK AIRSTRIP TENDER NO. KAA/OT/NAROK/0105/2024-2025				
BILL NO	DESCRIPTION	AMOUNT KSHS.			
ı	GENERAL				
4	SITE CLEARANCE AND TOPSOIL STRIPPING				
5	EARTHWORKS				
7	EXCAVATION AND FILLING OF STRUCTURES				
8	CULVERTS AND DRAINAGE WORKS				
10	GRADING AND GRAVELLING WORK				
12	NATURAL MATERIAL SUBBASE AND BASE				
14	CEMENT AND LIME TREATED SUBGRADE, SUBBASE& BASE.				
15	BITUMINOUS SURFACE TREATMENTS AND SURFACE DRESSING				
16	BITUMINOUS MIXES				
20	RUNWAY FURNITURE				
21	BOUNDARY PERIMETER FENCING				
22	DAY WORKS				
Α	SUB TOTAL I				
(a)	Add 5% of Sub-Total I of Bills as Provisional Sums for Contingencies to be expended in the whole or part or deleted as directed by the Engineer				
В	SUB TOTAL 2 (A+a)				
С	ADD 16% OF SUB-TOTAL B FOR VALUE ADDED TAX (VAT)				
D	TOTAL COST CARRIED FORWARD TO FORM OF BID (B+C)				

PROJECT: PROPOSED RUNWAY CONSTRUCTION WORKS AT NAROK AIRSTRIP					
TENDE	R NO. KAA/OT/NAROK/0105/2024-2025				
BILL NO	D. I : GENERAL				
	DESCRIPTION	UNIT	QUANTITY	RATE (KSH)	AMOUNT (KSH)
	Note: the following items for housing, offices and				
	involved in providing and maintaining such building	ıgs, includir	ng the Contract	or's overhe	ads and profit
	Office for the Engineer				
1.01	Provide and maintain Engineer's Representative's main	Lumpsum	I		
	office including furnishing the office as per the attached Appendix to Bill no. 1.01 (All furniture to revert to the				
	Contractor at the end of the Contract)				
	Provide and Maintain Laboratory for the Engineer	r			
1.02	Provide and maintain laboratory for use by the	Lumpsum	I		
	Resident Engineer and his staff for the entire duration				
	of the contract.				
1.03	Provide Laboratory equipment and reagents use by the	Lumpsum	I		
	Engineer's Representative for the duration of the contract as per the attached Appendix , Bill no 1.03				
	(All Laboratory equipment to revert to the Employer at the				
	end of the Contract)				
	Quality Control and Material Testing	•			
1.04	Allow a Prime Cost (PC Sum) of KShs; 1,200,000/=for	PC	1		
	the cost of performing Geotechnical Investigation as				
LOF	required Include percentage of P.C Sum in item 1.04 for	%			
1.05	contractor's overheads and profit.	76	1		
1.06	Allow a Prime Cost (PC Sum) of KShs :3,000,000/= for	PC	ı		
	Quality Control material testing including provision for				
	training materials Engineers, technicians/Technologists				
	and support staff services by MTRD of the Ministry of				
1.07	Roads and Transport.	0/			
1.07	Include percentage of P.C Sum in item 1.06 for contractor's overheads and profit.	%	I		
	Provide and maintain Survey Equipment				
1.08	Provide and maintain survey equipment for use by the	Lumpsum	1		
	Engineer's representative for the entire duration of the				
	contract as per the attached Appendix , Bill 1.08 (All				
	Survey equipment to revert to the Contractor at the end of				
	the Contract)				
1.00	Vehicle for the Engineer	\	10		
1.09	Provide driver, fuel, service, maintain and insure INo.clean 4WD double Cab pick-up vehicle, diesel	V.mth	18		
	engine capacity 2500-3000cc with not more than				
	30,000Km odometer reading, registered in Kenya not				
	earlier than January 2025 for exclusive use of the				
	Engineer inclusive of the first 5,000 km per vehicle				
	month to Engineer's approval. Vehicle to revert back to				
1.10	the contractor. E.O item 1.09 for total aggregated mileage in excess of	Km	50,000		
1.10	5,000 km per vehicle month.	KIII	30,000		
	Miscellaneous Account for Engineer	1			
1.11	Allow Prime Cost Sum (P.C. Sum) of Kshs. 3,000,000	P.C. Sum			
•	for the Resident Engineer's Miscellaneous account to be				
	spent in whole or part as directed by the Resident				
	Engineer against receipts				
1.12	E.O. item 1.11 for the contractor's overheads and	%			
	profit				

ENDE	R NO. KAA/OT/NAROK/0105/2024-2025				
ILL N	O. I : GENERAL				
	DESCRIPTION	UNIT	QUANTITY	RATE (KSH)	AMOUN ¹ (KSH)
	Daily Substance Allowance for the Project Implement	nentation 7	Геат (PIT)		
1.13	Allow Provisional sum amounting to Kshs.4,915,800/= as Daily Substance Allowance (DSA), fuel and miscellaneous to be expended in whole or part whose rates are to be determined by the Employer.	P.C. Sum	I		
1.14	E.O. item 1.13 for the contractor's overheads and profit	%			
	Attendance to the Engineer				
1.15	Allow Provisional sum amounting to Kshs. 16,940,000 for wages and allowances of a site supervisor and Engineers Site staff including overtime whose employment shall be determined by the Employer.	P.C. Sum			
1.16	E.O. item 1.15 for the contractor's overheads and profit	%			
	Training				
1.17	Allow a Prime Cost Sum (P.C. Sum) of KShs.3,500,000 for training of KAA staff on site for professional registration, attachees, interns and general training	P.C. Sum			
1.18	E.O. item 1.17 for Contractor's overheads and profits.	%			
	VIP Latrine				
1.19	Allow a Prime cost sum of Kshs .1,500,000/= for the construction of INo. Twin-door Ventilated Improved Pit (VIP) latrine block with urinal as per the Architectural drawings to the satisfaction of the Engineer.	PC Sum	1		
1.20	E.O item 1.19 for the contractor overheads and profits	%			
	Relocation of Services				
1.21	Allow Prime Cost Sum (P.C. Sum) of KShs 1,500,000/= for removal and alteration of services inclusive of liaison with the appropriate bodies in accordance with Specifications. Such services include water, power lines, telecommunication cables, etc.	PC Sum	I		
1.22	E.O item 1.21 for the contractor overheads and profits	%			

	DER NO. KAA/OT/NAROK/0105/2024-2025 NO. 4: SITE CLEARANCE AND TOPSOIL STRIPPII	NG			
BILL	DESCRIPTION UNIT QUANTITY				AMOUNT (KSH)
4.01	Site clearance Clear site including removal of hedges, bushes, trees including uprooting of trees stumps (except those designated to remain by the engineer) and other vegetation and objectionable materials in accordance with the specifications and backfill to 95 % MDD (AASHTO T99) with approved material of holes left by removal of stumps and roots as directed by the Engineer.	На	27		
4.02	Removal of topsoil Removal of unsuitable material / topsoil to a maximum depth of 200 mm deep or as directed by the Engineer and dispose-off to a site approved by NEMA and County Government. Removal/ Cutting of trees	m ³	53,602		
4.03	Removal/ cutting of tall trees in the runway approaches including uprooting of tree stumps diameter >450mm TOTAL OF BILL No.4 CARRIED FORWARD TO S	No.	30		

TEN	DER NO. KAA/OT/NAROK/0105/2024-2025				
BILL	NO. 5: EARTHWORKS				
	DESCRIPTION	UNIT	QUANTITY	RATE (KSH)	AMOUNT (KSH)
	Note: No separate payment shall be made for the ove be included in the rates and/or prices inserted	rhaul of	material and the	e cost of suc	
	Excavation				
5.01	Cut to spoil expansive materials to a depth not exceeding I.2m under the runway, taxiway, and apron areas and cart away and dispose- off to a site approved by NEMA and County Government.	m ³	91,614		
5.02	Cut to spoil expansive material not exceeding I.5m to achieve the recommended side slope of 2.5% to drain stormwater from the runway edge to the side drain as directed by the Engineer.	m ³	225,000		
5.03	Extra over item 5.01&5.02 for hard material.	m³	22,904		
	Rock Fill				
5.04	Provide, lay and compact in 200mm layers rockfill including filling of voids with stone dust (or equivalent) for areas under the runway, apron, and taxiway as directed by Engineer.	m³	36,646		
	Earthwork Fill				
5.05	Compact bottom of cut to 150mm to 95% MDD (AASHTO T99)	m ³	9,161		
5.06	Provide and place improved subgrade material CBR>20 Compacted to 100% MDD(AASHTO T99) in layers of 150mm to the satisfaction of the Engineer.	m³	22,262		
	Pest Control				
5.07	Destroy termite colonies and treat existing ground with METRO 200SC (or equivalent approved termicide), after dilution (1:800) at the rate of 5 liters per square metre or any other equal and approved insecticide treatment. application to be undertaken by a person registered with Pest Control Products Board (PCBP) and approved by the Engineer. and subject to a Ten (10) Year Guarantee Certificate endosed by the manufacturer.	m²	64,283		

PRO	PROJECT: PROPOSED RUNWAY CONSTRUCTION WORKS AT NAROK AIRSTRIP						
TEN	DER NO. KAA/OT/NAROK/0105/2024-2025						
BILL	NO. 7: EXCAVATION AND FILLING OF STRUCTURE	S					
	DESCRIPTION	UNIT	QUANTITY	RATE (KSH)	AMOUNT (KSH)		
	Note: No separate payment shall be made for the over be included in the rates and/or prices inserted	haul of m	aterial and the	cost of such h	naulage shall		
7.01	Excavation in soft material for major structures i.e. culverts and gabions.	m ³	250				
7.02	Extra over item 7.01 but in hard material.	m ³	50				
7.03	Provide and place macaferri or equivalent gabion boxes and mattresses as specified.	m ²	165				
7.04	Provide and place rock fill to gabions.	m³	30				
7.05	Provide stone pitching including cement grouting as directed by the Engineer.	m ²	1,200				
	TOTAL OF BILL No.7 CARRIED FORWARD TO SUM	IMARY					

PROJ	PROJECT: PROPOSED RUNWAY CONSTRUCTION WORKS AT NAROK AIRSTRIP					
TENI	DER NO. KAA/OT/NAROK/0105/2024-2025					
BILL	NO. 8: CULVERTS AND DRAINAGE WORKS					
	DESCRIPTION	UNIT	QUANTITY	RATE (KSH)	AMOUNT (KSH)	
	Note: No separate payments shall be made for gravel for excavation materials and the cost of such shall be include				le	
8.01	Excavate for V-shaped in section stormwater open drain n.e I.5m deep and average 2500mm wide inclusive of trimming embarkments to slope and cart away	m³	8,925			
8.02	Excavate for inlet, outfall, mitre and catch water drains in soft material.	m³	450			
8.03	Extra over items 8.01 & 8.02 for excavation in hard material.	m³	180			
8.04	Approved crushed rock fill in subsoil drains and rockfill under culverts	m³	100			
8.05	Provide, lay and joint single 900 mm inner diameter (ID) precast concrete pipes including bed, surround and haunches.	LM	40			
8.06	As item 8.05 but 600mm inner diameter (ID) precast concrete pipes	LM	80			
8.07	Provide and place class 20/20 reinforced concrete to headwalls, wing walls, aprons, to pipe culverts including formwork and reinforcement.	m³	85			
8.08	Provide and fix steel fabric reinforcement to BS 4483 size A142 where directed by the Engineer.	m²	220			
	TOTAL OF BILL No.8 CARRIED FORWARD TO SUMM	IARY				

PROJE	PROJECT: PROPOSED RUNWAY CONSTRUCTION WORKS AT NAROK AIRSTRIP						
TEND	TENDER NO. KAA/OT/NAROK/0105/2024-2025						
BILL	BILL NO. 10: GRADING AND GRAVELLING WORK						
	DESCRIPTION	UNIT	QUANTITY	RATE (KSH)	AMOUNT (KSH)		
	Note: No separate payments shall be made for gravel for blinding or hauling to spoil unsuitable excavation materials and the cost of such shall be included in the rates and prices						
	Rehabilitation of existing gravel access road to the airstri same.	p: Rates	to include cost o	f reinstateme	ent of the		
	Grading and Gravelling Works						
10.01	Heavy grading, spot gravelling with watering of the 7.0m access roads to the satisfaction of the Engineer and as per the specifications.	m²	3,000				
	TOTAL OF BILL No.10 CARRIED FORWARD TO SUM	MARY					

PROJE	CT: PROPOSED RUNWAY CONSTRUCTION WORK	S AT NAR	OK AIRSTRIP		
TENDE	R NO. KAA/OT/NAROK/0105/2024-2025				
BILL N	O. 12: NATURAL MATERIAL BASE AND SUB-BASE				-
	DESCRIPTION	UNIT		RATE	
			QUANTITY	(KSH)	AMOUNT (KSH)
	measurement in the standard specifications. After tree least 160% measured after 7-day cure and 7-day soak (AASHTO T180) and the treated material shall have Modulus less than 250.(As specified in Clause 12.03 of t Construction 1986)	on the site a Plasticity	e mix compacte y Index less tha	ed to at leas in 6% and a	t 95% MDD Plasticity
	Material for selected base and subbase				
12.01	Provide, place, spread and compact natural gravel minimum soak 4 days CBR >30% at 95% MDD (AASHTO TI80) compaction for Subbase.	M³	9,211		
12.02	Provide, place, spread and compact natural gravel minimum soak 4 days CBR >80% at 95% MDD (AASHTO T180) compaction for Base	M³	9,211		
	TOTAL OF BILL No.12 CARRIED FORWARD TO S	UMMARY			

PROJECT	PROJECT: PROPOSED RUNWAY CONSTRUCTION WORKS AT NAROK AIRSTRIP							
TENDER	TENDER NO. KAA/OT/NAROK/0105/2024-2025							
BILL NO.14: CEMENT AND LIME TREATED SUBGRADE, SUBBASE& BASE.								
SNo.	DESCRIPTION			RATE	AMOUNT			
		UNIT	QUANTITY					
	Provide, transport to site, store and spread	Tonne						
14.01	Ordinary Portland Cement to gravel material for		520					
	Base or as specified and as instructed by the							
	Engineer at 30- 60 kg/m3 at the point of works							
	including all handlings. (Mixing to be done using a							
	Pulve mixer)							
	Allow for mixing in cement and/or lime into	m ³						
14.02	natural gravel.		8,663					
	Allow for curing and protection of treated layers	m ²						
14.03	as specified		56,584					
TOTAL	OF BILL No. 14 CARRIED FORWARD TO SUMM	ARY SH	EET					

PROJECT: PROPOSED RUNWAY CONSTRUCTION WORKS AT NAROK AIRSTRIP

TENDER NO. KAA/OT/NAROK/0105/2024-2025

BILL NO. 15: BITUMINOUS SURFACE TREATMENTS AND SURFACE DRESSING

	DESCRIPTION	UNIT	QUANTITY	RATE (KSH)	AMOUNT (KSH)
	Prime Coat MC-30				
15.01	Prepare surface, provide, heat and spray MC-30 cutback bitumen as prime coat to Runway, Taxiways, Apron and Accesses; all in accordance with the specifications and as directed by the Engineer. (0.8 - 1.2 l/m²)	Litre	56,584	200	
	Tack Coat KI - 60				
15.02	Provide & spray cationic emulsion KI-60 as tack coat on runway, taxiway and apron surfaces at a rate of 0.3-0.8 l/m ²	Litre	45,267	180	
	TOTAL OF BILL No.15 CARRIED FORWARD TO S				

BILL NO. 16: BITUMINOUS MIXES							
Item No.	Description	Units	Quantity	Unit Bid Rate(Ksh)	Amount KSh		
16.01	Provide, place and compact 30mm asphalt concrete Type I (0-14mm) with 5.0-6.5% nominal bitumen content by weight to total mix as Base Course on Runway, Taxiways & Apron as directed by Engineer.	m ³	1,733				
16.02	Provide, place and compact 30mm asphalt concrete Type I (0-14mm) with 5.5-7.0% nominal bitumen content by weight to total mix as Wearing Course on Runway, Taxiways & Apron as directed by Engineer.	m ³	1,733				

TEND	DER NO. KAA/OT/NAROK/0105/2024-2025				
BILL	NO. 20: RUNWAY FURNITURE				
	DESCRIPTION	UNIT	QUANTITY	RATE (KSH)	AMOUNT (KSH)
	Runway Marking and Runway Signs				
	Runway Marking				
20.01	Prepare surface and paint with approved reflectorized white and yellow road marking paints for pavement marking as directed by the Engineer	No	4,250		
	Project Signboard				
20.02	Provide project signboard being I200mm x 600mm Gauge I4 (I.99mm thick) mild steel plate welded onto 50mm x 50mm x 3mm square hollow sections frame, 2.5m frame with 0.5m fixed below ground, and painted KAA colours for the duration of the project including the defects liability period	No	I		
	Airport Directional Signs				
20.03	Provide and install Airport directional signs according to the provided details as directed by the Engineer	No	2		
	Windsock				
20.04	Provide and erect Windsock complete with Mast fixed to the ground	No	2		
	Road Kerbs				
20.05	Excavate for, provide & place 250 x 125mm precast concre 15/20 concrete base bedding and mortar joined in support Engineer.				
	a) Straight kerbs	LM	480		
	b) Kerbs radius 12m - 6m	LM	50		
	c) Ditto but radius 5m - 1m	LM	50		
	As 20.05 but for flush kerbs 100 x 125mm	LM			

PROJ	PROJECT: PROPOSED RUNWAY CONSTRUCTION WORKS AT NAROK AIRSTRIP							
TEND	DER NO. KAA/OT/NAROK/0105/2024-2025							
BILL	NO. 21: BOUNDARY PERIMETER FENCING							
	DESCRIPTION	UNIT	QUANTITY	RATE (KSH)	AMOUNT (KSH)			
21.01	Excavate holes of 450mm diameter and up to 1000mm deep, and cart away waste material to spoil dumps.	CM	365					
21.02	As item 21.01, but in hard material.	CM	91					
21.03	Provide and install 3.0m minimum overall length and maximum width of 125mm × 125mm reinforced concrete grade B (1:1.5:3 mix) intermediate posts (cranked at the top) at 3.0-meter centre to centre with 7 No. holes for straining wires/barbed wire hook bolts, with Y10 reinforcement, including concreting of the posts holes up to the ground level.	No	1,835					
21.04	As in item 21.03 above but for strainer posts up to 3.0m overall length and maximum width of 200mm, and Y10 reinforcement.	No	85					
21.05	As in item 21.03 but for strainer post struts up to 3.0m overall length and maximum width of 100mm to be placed on either side of strainer posts at 45 degrees to the ground, and Y10 reinforcement.	No	170					
21.06	Provide and fix 3.0 m wide heavy-duty galvanized chainlink; Gauge 10 (3.0 mm diameter) ; 50x50mm mesh onto precast concrete posts (m/s); fastening with 5 No. lines of galvanized wire (m/s); threaded through and including mesh and hook bolts; secured by binding wire; all as per detail drawings.	М	5,500					
21.07	Provide and fix 3 lines of galvanized barbed wire 12 1/2 gauge (2.5mm diameter) onto the cranked sections of the concrete posts threaded through the holes on the posts.	М	16,500					
21.08	Supply and Install Hot hot-dipped galvanized Ripper Steel Spiral razor wire (CONCERTINA COIL) 2.5 mm dia. High Tensile, blade/strip 0.55mm, clips 2.0mm, diameter 10mm with hot dipped galvanized surface treatment along the inner face of the fence in 3 layers to Engineer's instructions, in concertina coil of loops 250mm long, 300mm diameter. Length to be measured for each coil separately. (COIL TO BE PLACED AT TOP & BOTTOM TO FENCE).	М	16,500					
21.09	Supply, fabricate and install galvanized heavy-duty metal gate overall size 6000 x 2400mm high; in two equal leaves; with and including 100 x 100 x 6mm SHS fixed firmly to the ground in approved concrete base; 8 gauge welded wire mesh covering fixed to 50 x 50 x 4mm SHS and tower locking heavy gauge bolt (including VIRO Cylinder 104); 3 lines of 12.5 gauge barbed wire at the top of each leaf; all as per attached drawings and approval of Project Manager. Gate to be painted in three coats of approved protective paint.	No	3					
21.10	Supply materials, fabricate and install galvanized heavyduty metal gate overall size 1000 x 2400mm high pedestrian gate with and including 75 x 75 x 4mm SHS fixed firmly to the ground in approved concrete base; 8 gauge welded wire mesh covering fixed to 50 x 50 x 4mm SHS and tower locking heavy gauge bolt (including VIRO Cylinder 104); 3 lines of 12.5 gauge barbed wire at the top; all as per attached drawings and approval of Project Manager. Gate to be painted in three coats of approved protective paint. Rate inclusive of casting of beam.	No	I					

PROJ	PROJECT: PROPOSED RUNWAY CONSTRUCTION WORKS AT NAROK AIRSTRIP							
TEND	PER NO. KAA/OT/NAROK/0105/2024-2025							
BILL	BILL NO. 21: BOUNDARY PERIMETER FENCING							
	DESCRIPTION	UNIT	QUANTITY	RATE (KSH)	AMOUNT (KSH)			
21.11	Provide well compacted/vibrated concrete class 20/20mm	n – (1:2:4) as o	described in:					
	a)Ground beams	CM	430					
	b)Regulating concrete at steep areas up to 100mm	CM	108					
	c)Regulating concrete at steep areas up to 200mm	CM	143					
	TOTAL OF BILL No.21. CARRIED FORWARD T	O SUMMAR	Ý					

PROJEC	T: PROPOSED RUNWAY CONSTRUCTION WORKS	AT NARO	K AIRSTRIP	
TENDE	R NO. KAA/OT/NAROK/0105/2024-2025			
BILL NO	D.22: DAYWORKS (RATES ONLY)			
LABOU	R			
	for labour must be priced. Only the actual time engage			
	herein shall include all costs of labour as well as overtim			
	contributions, use and maintenance of small tools of tra	de, supervisi	ion, insurance, ove	rheads, profits and
any otne 22.01	r cost allowance. Unskilled Labour	Hrs		
22.01	Oliskilled Labout	1115	120	
22.02	Carpenter/ stone mason	Hrs	120	
			120	
22.03	Blaster (or certified explosives handler)	Hrs		
	•		120	
22.04	Artisan	Hrs		
			120	
22.05	Watchman (all round surveillance)	Hrs	120	
22.04			120	
22.06	Senior Foreman having Higher National Diploma (HND) and at least 10 years experience	Hrs	120	
22.07	Foreman having Ordinary Diploma (OD) and at	Hrs	120	
22.07	least 5 years experience	1115	120	
	reast o years experience		120	
22.08	Senior Surveyor having Higher National Diploma	Hrs		
	(HND) and at least 10 years experience		120	
22.09	Surveyor having Ordinary Diploma (OD) and at	Hrs		
22.09	least 5 years experience	1115	120	
22.10	• •	**	120	
22.10	Graduate Engineer	Hrs	120	
22.11	Registered Engineer	Hrs	120	
22.11	Registered Engineer	1115	120	
MATER	IALS			
All mate	rials should comply with the specifications. The rates in	serted herein	are to include for	delivery to site,
	handling, overheads and profit			
22.12	Ordinary Portland Cement	Tonne		
			10	
22.13	Hydrated Lime	Tonne		
00.14			1	
22.14	Aggregates for Concrete	3		
	a) Sand	m ³	1	
	b) Coarse aggregate (12mm)	m ³	1	
	b) Course aggregate (12mm)	""	1	
	c) Coarse aggregate (20mm)	m ³		
			1	
22.15	Shuttering Timber			
	Class F1 finish	m ²		
			1	
	Class F3 finish	m ²		
22.16	Mild Shool		1	
22.16	Mild Steel	Tonne		
	a) Up to and including 16mm diameter	TOTHE	1	
	b) Over 16mm diameter size	Tonne	1	
	2, 5 to round diameter size	1011110	1	
			-	i i

PROJECT	Γ: PROPOSED RUNWAY CONSTRUCTION WORK	S AT NARO	K AIRSTRIP	
TENDER	NO. KAA/OT/NAROK/0105/2024-2025			
BILL NO	0.22: DAYWORKS (RATES ONLY)			
	a) Up to and including 16mm diameter	Tonne	1	
22.18	Bitumen		1	
	a) 80/100 Penetration Grade Bitumen	Litre	1	
	b) MC 30 Cutback Bitumen	Litre	1	
	c) MC 3000 Cutback Bitumen	Litre	1	
	d) K 1-70 Bitumen Emulsion	Litre	1	
	e) Kerosine	Litre	1	
22.19	Asphalt Concrete Type 1		*	
	a) 0/14mm grading	m ³	1	
	b) 0/20mm grading	m³	1	
22.20	Class 2-3 Chippings for Bituminous Surface Dress	ing		
	a) 0/6 mm (quarry dust)	m ³	1	
	b) 6/10mm	m ³	1	
	c) 10/14mm	m ³	1	
	d) 14/20mm	m ³	1	
22.21	Approved quarry waste	Tonne	1	
22.22	Hard-core	Tonne	1	
22.23	Building Stone	Tonne	1	
22.24	Gravel			
	a) Natural Base Standard Gravel (Minimum CBR-80%)	m³	1	
	b) Natural Sub-Base Standard Gravel (Minimum CBR- 30%)	m ³	1	
	c) Natural Gravel for shoulders (Minimum CBR-20%)	m ³	1	
22.26	Gabion Mesh (2.0x1.0x1.0)m	m ²	1	
22.27	Rock fill to Gabions	m ³	1	
22.28	Barbed Wire heavy gauze	Roll	1	
22.29	Nails (All sizes)	Kg	1	
22.30	Cedar post 100mm diameter by 1000mm long	No.	1	
22.31	Provide, lay and joint 300x150mm half-battered kerbs to raised footpaths	m	1	

PROJEC*	T: PROPOSED RUNWAY CONSTRUCTION WORK	S AT NARO	OK AIRSTRIP	
TENDER	NO. KAA/OT/NAROK/0105/2024-2025			
BILL NO	0.22: DAYWORKS (RATES ONLY)			
22.32	Provide, lay and joint 125x100mm channel blocks to raised footpaths	m	1	
	PLANT & EQUIPMENT			<u>, </u>
Where ite	ems of major plant listed in the schedule of Day works	are specified	l by type (e.g. Cat D	7, Cat 120H) the
	ting of such plant is that manufactured within the two			
	works which have power rating lower that that stated			
	of day works. The deduction in the payable rates shall			
	above plant.	1 1	1	O
22.33	Cat D6 bull dozer or equivalent with Dozer/	Hr		
	Ripper attachment.		1	
22.34	Cat 140H motor grader or equivalent complete	Hr		
	with scarifier.		1	
22.35	Vibrating roller (10 tonnes).	Hr		
			1	
22.36	Hand propelled vibrating roller.	Hr	_	
	and frequency various & rester.		1	
22.37	Hand held Lawn mower	Hr	-	
	Thata hera barri mower		1	
22.38	Cat 950G wheel loader or equivalent.	Hr	1	
22.00	cat 5000 wheel loader of equivalent.	111	1	
22.39	15 tonne tipper lorry.	Hr	1	
22.07	13 tornie upper forry.	111	1	
22.40	10 tonne tipper lorry.	Hr	1	
22.40	To tornie upper forry.	111	1	
22.41	50 mm Delivery vicator numn and mater	Hr	1	
ZZ. 4 1	50 mm Delivery water pump and motor.	П	1	
22.42	Concrete mixer 0.3 - 0.7 m ³ /min.	Hr	1	
22.42	Concrete mixer 0.5 - 0.7 mg/mm.	111	1	
22.43	15 tonne pneumatic self-propelled roller.	Hrs	1	
22.43	13 torine priedmatic sen-propened roner.	1115	1	
22.44	As item 22.43 but 10 tonnes.	Hrs	1	
22.44	As item 22.45 but 10 tollines.	ITIS	1	
22.45	16 10 toward out to the colored well on	T T	1	
22.45	16-18 tonnes smooth wheel roller.	Hrs	_	
22.46	As item 22.45 but 12 tonne.	Hrs	1	
22.40	As item 22.45 but 12 tonne.	nrs	_	
22.47	As item 22.45 but 10 tonne.	Hrs	1	
22.47	As item 22.45 but 10 tonne.	nrs		
22.40		T T	1	
22.48	One ton hand-propelled vibrating roller.	Hrs	_	
22.40	TT11-11	TT	1	
22.49	Hand held rammer compactor or equivalent.	Hrs	_	
22.50	4.7.2	T.T.	1	
22.50	1.7m ³ excavator with loader attachments	Hrs		
22.54	4 4 20 501 442 2		1	
22.51	As item 22.50 but 13m ³	Hrs		
22.52			1	
22.52	As item 22.50 but 1.1m ³	Hrs		
22.52			1	
22.53	As item 22.50 but 0.6m ³	Hrs		
22.7			1	
22.54	A half to one & a half tonne capacity pick-up.	Hrs	_ [
22.55	0 11 (050 () 1 11 11	**	1	
22.55	Compressor dia. (250 c.f.m.) complete with all	Hrs		
	tools, horses, steels etc.		1	

PROJEC	PROJECT: PROPOSED RUNWAY CONSTRUCTION WORKS AT NAROK AIRSTRIP						
TENDER	R NO. KAA/OT/NAROK/0105/2024-2025						
BILL NO	0.22: DAYWORKS (RATES ONLY)						
22.56	50-75mm delivery water pump and motor.	Hrs	1				
22.57	Concrete vibrator (poker type).	Hrs	1				
22.58	Self-propelled water tanker 6,000-10,000 litre minimum capacity with pick-up pump.	Hrs	1				
22.59	Mechanical broom	Hrs	1				
22.60	Pressure bitumen distributor 4500-8000 litres capacity.	Hrs	1				
22.61	As item 22.60 but 3000 litres.	Hrs	1				
22.62	Mechanical chips spreader	Hrs	1				
TOTAL	DAYWORKS						

APPENDIX TO BILL ITEM 1.01: PROVIDE, FURNISH AND MAINTAIN THE R.E.'S OFFICE						
ITEM	DESCRIPTION	UNIT	Quantity	Rate (Kshs)	Total Amount (Kshs.)	
A101/1.01	Construct and maintain the RE'S office for the entire contract period, rate includes the building, security, water, electricity, gas, cleaning, tea, coffee etc in accordance with the specifications. Measurement and payments to be done in accordance with clause 141 (b) of the standard Specs. The Layout drawing for the Site office is as per the standard drawing attached.	Item	1.00			
A101/1.02	3 Drawer steel filing cabinet	No	2.00			
A101/1.03	Executive desk 2.2 x 0.9 m with six lockup drawers	No	2.00			
A101/1.04	Standard office desk with three lockup drawers	No	3.00			
A101/1.05	Standard office chairs	No	6.00			
A101/1.06	Bench 3 m long with cushioned backrest (located as directed)	No	1.00			
A101/1.07	Typist's desk	No	1.00			
A101/1.08	Typist's chair	No	1.00			
A101/1.09	Lockable steel stationery cupboard, 1.2 m³, lockable	No	1.00			
A101/1.10	Medium size steel filing cabinet, 4 drawers lockable	No	2.00			
A101/1.11	Bookshelf, 1.5 m wide 3 shelves (for box files) sliding glass door	No	2.00			
A101/1.12	Conference table with 12 chairs	No	1.00			
A101/1.13	Curtains for office and laboratory - for all windows and doors	Set	2.00			
A101/1.14	Ceiling fans	No	3.00			
A101/1.15	Air conditioner unit, I2000 BTU/hr	No	1.00			
A101/1.16	Pendant / Battery powered wall clock	No	2.00			
A101/1.17	Dust bins	No	3.00			
A101/1.18	Filing Tray	No	4.00			
A101/1.19	Refrigerator minimum capacity 0.2 m³	No	1.00			
A101/1.20	Cupboard, 0.15 m³, lockable	No	1.00			
A101/1.21	Cooker 4 plate electric cooker with oven and grill	No	1.00			
A101/1.22	Intel Pentium i7 laptop computer	No.	2.00			
A101/l.23	Intel Pentium i5 Desktop computer	No.	2.00			
A101/1.24	Digital camera (Equal or greater than 15.2 megapixels)	No.	1.00			
A101/1.25	Uninterruptable high-speed internet supply	Months	18.00			
A101/1.26	Stapling machine Ofrex size 50 or similar with 5000 staples	No.	3.00			
A101/1.27	Ordinary 2-hole paper punch	No.	2.00			

APPENDI	X TO BILL ITEM 1.01: PROVIDE, FURNISH AND N	1AINTAIN	THE R.E.'S OI	FFICE	
ITEM	DESCRIPTION	UNIT	Quantity	Rate (Kshs)	Total Amount (Kshs.)
A101/1.28	Heavy duty 2 hole paper punch	No.	2.00		
A101/1.29	Heavy duty punch and spiral binder, IBICO AG or similar approved	No	2.00		
A101/1.30	Reams of A4 photocopying paper	No	100.00		
A101/1.31	Reams of A3 photocopying paper	No	50.00		
A101/1.32	First Aid kit	No.	2.00		
A101/1.33	A3 & A4 Multifunction Colour Printer and Photocopier (approved make) with feeder sorting trays, accessories and supplies sufficient to complete the project	No.	1.00		
A101/1.34	UPS IKVA surge protector	No	3.00		
A101/1.34	Fire Extinguisher	No	2.00		
A101/1.36	2 No Civil 3D (Latest Version) & I No. Civil Cad (Latest Version). The quote to include buying of the software and training of the Client Engineer's as will be directed by the Engineer	No.	3.00		
	Total carried Forward to Bill Item 1.01				

ITEM	DESCRIPTION	UNIT	Quantity	Rate (Kshs)	Total Amount (Kshs.
	I. FURNITURE				
A103/1.01	Meeting table (3.0 x 1.2 m) with 6 chairs	No.	1.00		
A103/1.02	Ceiling fans	No.	4.00		
A103/1.03	Air conditioner unit, 12000 BTU/hr	No.	2.00		
A103/1.04	Desk 2.2 × 0.9 m with 2 chest of drawers	No.	2.00		
A103/1.05	Office chairs, standard	No	6.00		
A103/1.06	Chairs with arms	No.			
A103/1.07	Table (I.5 x .75 m) with 2 drawers and 2 chairs	No.	1.00		
A103/1.08	4-drawer Steel lockable filing cabinet	No.	2.00		
A103/1.09	Electronic scientific calculator, 12 figures	No.	4.00		
A103/1.10	Fire extinguisher, 10 litre capacity, CO2 type	No.	2.00		
A103/1.11	Steel filing cabinet, 4 drawers, lockable	No	1.00		
A103/1.12	Steel filing cabinet, 2 drawers, lockable	No	1.00		
A103/1.13	Book shelf, 3 shelves 1.2 m long (to hold box files)	No.	2.00		
A103/1.14	First aid kit	No.	1.00		
A103/1.15	Snake bite kit	No.	1.00		
A103/1.16	Water filters	No.	2.00		
	2. EQUIPMENT				
A 102/1 :=	i. General Equipment				
A103/1.17	Compaction mould complete with base plate and extension collar. 101.6 mm dia x 116.43 mm high	No.	4.00		
A103/1.18	2.5 kg Compaction rammer, drop regulated to 304.8 mm	No.	4.00		
A103/1.19	4.535 kg compaction rammer, drop	No.			

ITEM	DESCRIPTION	UNIT	Quantity	Rate (Kshs)	Total Amount (Kshs.)
A103/1.20	Straight edge 300 mm long, with handles	No.	6.00		
A103/1.21	Electric vibrating Kango Hammer fitted with steel tamper (BS 1377) with support frame	No.	1.00		
A103/1.22	Steel Tamper (BS 1377) compatible with Kango hammer	No.	4.00		
A103/1.23	Compaction mould complete with base plate and extension collar, 152.4 mm dia x 16.43 mm high	No.	4.00		
A103/1.24	Galvanized sample tray I x 0.5 x 75 mm deep	No.	6.00		
A103/1.25	75 mm brush	No.	10.00		
A103/1.26	Semi-automatic Electronic balance , 25 kg capacity accurate to 10g, including weights	No.	1.00		
A103/1.27	20 mm BS sieve, 300 mm diameter	No.	2.00		
A103/1.28	Stop Clock	No.	2.00		
A103/1.29	Thermostatically controlled electric oven I 04 - I I 0 °C, capacity 0.225 m'	No.	2.00		
A103/1.30	As above but gas heated	No.	1.00		
A103/1.31	Moisture tin, 90 mm dia x 20 mm deep, cadmium plated or aluminium alloy	No.	100.00		
A103/1.32	Cone penetrometer with gauge and automatically controlled test cup	No.	1.00		
A103/1.33	Test gauge	No.	1.00		
A103/1.34	Penetration test cup	No.	2.00		
A103/1.35	Penetration test cone	No.	3.00		
A103/1.36	Glass comparator	No.	2.00		
A103/1.37	Glass plate	No.	2.00		
A103/1.38	Evaporating Dish 150mm diax45mm depth	No.	4.00		

ITEM	DESCRIPTION	UNIT	Quantity	Rate (Kshs)	Total Amount (Kshs.
A103/1.39	Metal container (450 mm dia.)	No.	4.00		
A103/1.40	Stainless steel tray, 305 mm dia x 50 mm deep	No.	4.00		
A103/1.41	Metal tray with 150 mm dia hole in centre, 300 x 300mm square or equivalent area, 400 mm deep	No.	3.00		
A103/1.42	Metal tray with 200mm dia hole in centre, 500 x 500mm square 50 mm deep	No.	3.00		
A103/1.43	Steel pegs for fixing tray in position	No.	20.00		
A103/1.44	Sand pouring cylinder, 150 mm dia	No.	5.00		
A103/1.45	Sand pouring cylinder, 215 mm dia	No.	5.00		
A103/1.46	Cold steel chisel 20 x 300 mm long	No.	6.00		
A103/1.47	Cold steel chisel 10 x 250 mm long	No.	6.00		
A103/1.48	I.5 kg (2 off), 3.5 kg (2 off) mason hammers and I kg (2 off) rubber mallet	Set	3.00		
A103/1.49	Scoop for removing excavated material from hole, 250 mm long handle	No.	10.00		
A103/1.50	100 mm brush, soft	No.	4.00		
A103/1.51	50 mm brush, soft	No.	6.00		
A103/1.52	Primus gas stove	No.	3.00		
A103/1.53	Calibration can 150 mm dia x 150 mm deep	No.	4.00		
A103/1.54	Ditto item 54/106 but 200 mm dia x 250 mm deep	No.	4.00		
	vi. Sieve Analysis (BS 1377)				
A103/1.55	Sieve 300 mm dia:75,63,50,37.5,28, 25,19,20,14,12.5,10,9.5,6.3,5,4.75 and 4 mm, plus lid and receiver	Set	3.00		
A103/1.56	Sieve 200 mm dia: 2.36.,2,1.18,1,0.6,0.5,0.425,0.300,0.150 and 0.075mm plus lid and receiver	Set	3.00		
A103/1.57	Electric Sieve shaker	No.			


ITEM	DESCRIPTION	UNIT	Quantity	Rate (Kshs)	Total Amount (Kshs.)
A103/1.58	I.2 x I.2 m x 50 mm deep galvanized metal tray	No.	15.00		
A103/1.59	Riffle box with 50 mm slots	No.	2.00		
	xi. Miscellaneous		2.00		
A103/1.60	Gas cylinders 13 kg	No.	2.00		
A103/1.61	Padlocks	No.	6.00		
A103/1.62	Plastic jerry 201 capacity	No.	6.00		
A103/1.63	Paper punch	No.	2.00		
A103/1.64	Stapler with pins	Pkts	10.00		
A103/1.65	Tray lifting callipers	No.	4.00		
A103/1.66	Laboratory dust coats-Brown	No.	10.00		
A103/1.67	Laboratory dust coats-White	No.	10.00		

APPENDIX TO BILL ITEM 1.08: PROVIDE AND MAINTAIN SURVEY EQUIPMENT							
ITEM	DESCRIPTION	UNIT	Quantity	Rate (Kshs)	Total Amount (Kshs.)		
A107/1.01	Engineer's Automatic/dumpy Level with accessories and tripod	No	2.00				
A107/1.02	Total station complete with a Field Data collector Leica, equivalent including accessories and supporting software (I") [plus tripod	No	1.00				
A107/1.03	Survey umbrella	No	3.00				
A107/1.04	Levelling staff 5m , 5 section with levelling bubble	No	6.00				
A107/1.05	3m, 3 section ranging rod	No	10.00				
A107/1.06	Laser distancer	No	2.00				
A107/1.07	Walkie Talkies	No	4.00				
A107/1.08	Prism pole	No	4.00				
A107/1.09	50m fireglass measuring tape	No	5.00				
A107/1.10	7m tape measure	No	5.00				
A107/1.11	Prism pole holder	No	4.00				
A107/1.12	Pangas (16")	No	4.00				
A107/1.13	Drawing office stools	No	4.00				
A107/1.14	Sledge hammer 2kg weight	No	4.00				
A107/1.15	Refrlective road safety vests	No	20.00				
A107/1.16	Rapid charger	No	1.00				
A107/1.17	Spare batteries	No	4.00				
A107/1.18	Optical squares	No	4.00				
A107/1.19	Spirit level for staves	No	4.00				
A107/1.20	Steel hammer (4kg)	No	2.00				
A107/1.21	Tripple prism mount with reflectors	No	3.00				
A107/1.22	Level books (Rise and Fall)	No	50.00				
A107/1.23	RTK GPS set consisting of base+ Rover and accessories (including external radio)	No	1.00				
Total carried F	forward to Bill Item 1.08						



PROPOSED RUNWAY CONSTRUCTION AT NAROK AIRSTRIP DRAWING LIST- FEBRUARY 2025 KAA/OT/NAROK/0105/2024-2025

SR.NO	DRG.NOS	DESCRIPTION	SCALE	SIZE	Comments
		Layouts			
I.	L[01]01	Airstrip Layout Plan	1:3500	ΑI	
2.	L[01]02	Apron Layout Plan	1:1,000	AI	
3.	L[01]03	Airstrip Map	As Shown	ΑI	
4.	L[01]04	Runway Alignment & Profile	1:2,000	ΑI	
5.	L[01]05	Runway Cross - Sections	1:2,000	ΑI	
6.	L[01]06	Taxiway Alignment & Profile	1:1,000, 1:500	ΑI	
7.	L[01]07	Standard Site Office	1:100	AI	
		Details			
8.	A[01]01	Project Signboard	As Shown	A3	
9.	A[01]02	Standard Culvert Details	1:75,1:50,1:20	A3	
10.	A[01]03	Windsock Details	1:20	A3	
11.	A[01]04	Latrine Layout	1:100	A3	
12.	A[01]05	Standard Fence Details	As Shown	A3	
13.	A[01]06	Security Gate Details	1:100	A3	
14.	A[01]07	Pedestrian Gate Details	1:100	A3	
15.	A[01]08	Road Kerb and Channel Detail	1:20	A3	

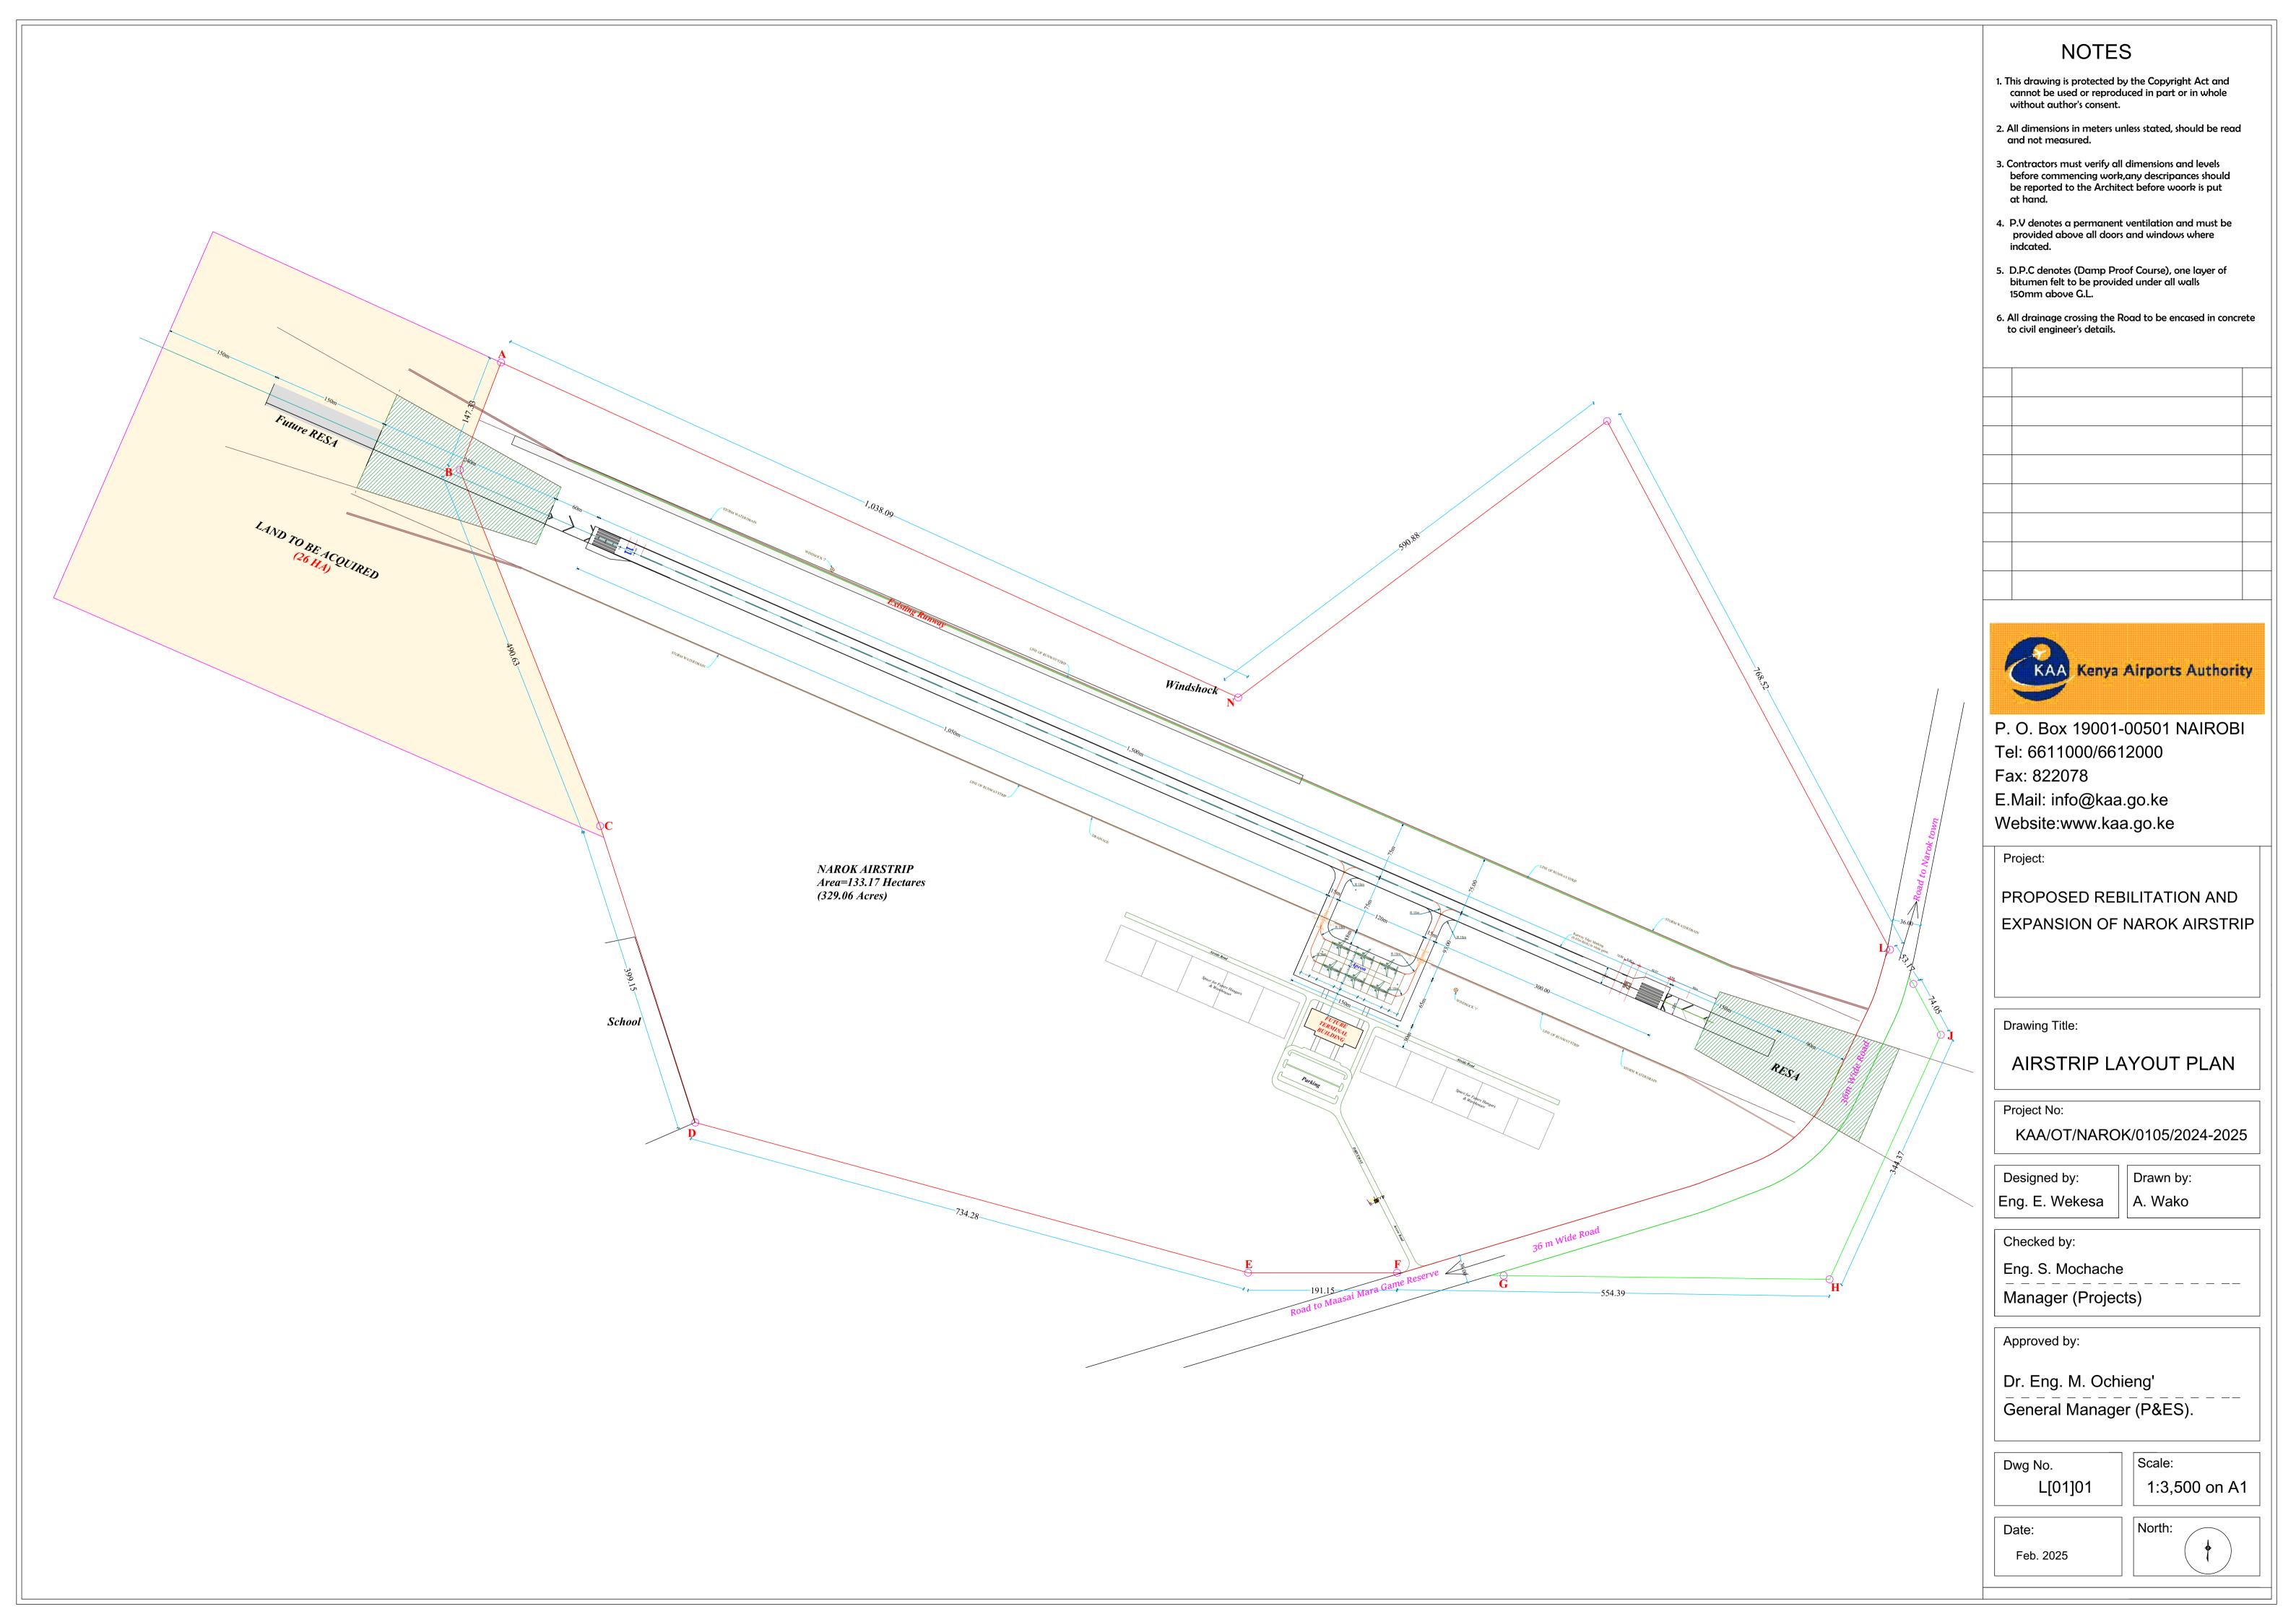



- This drawing is protected by the Copyright Act and cannot be used or reproduced in part or in whole without author's consent.
- All dimensions in meters unless stated, should be read and not measured.
- 3. Contractors must verify all dimensions and levels before commencing work, any descripances should be reported to the Architect before woork is put
- P.V denotes a permanent ventilation and must be provided above all doors and windows where indcated.
- D.P.C denotes (Damp Proof Course), one layer of bitumen felt to be provided under all walls 150mm above G.L.
- 6. All drainage crossing the Road to be encased in concrete



P. O. Box 19001-00501 NAIROBI Tel: 6611000/6612000

Fax: 822078

E.Mail: info@kaa.go.ke Website:www.kaa.go.ke

Project:

PROPOSED REBILITATION AND EXPANSION OF NAROK AIRSTRIP

Drawing Title:

APRON LAYOUT PLAN

Project No:

KAA/OT/NAROK/0105/2024-2025

Designed by:

Eng. E. Wekesa

Drawn by:
A. Wako

Checked by:

Eng. S. Mochache

Manager (Projects)

Approved by:

Dr. Eng. M. Ochieng'

General Manager (P&ES).


Dwg No. L[01]02

Scale: 1:1,000 on A2


Date: Feb. 2025


North:




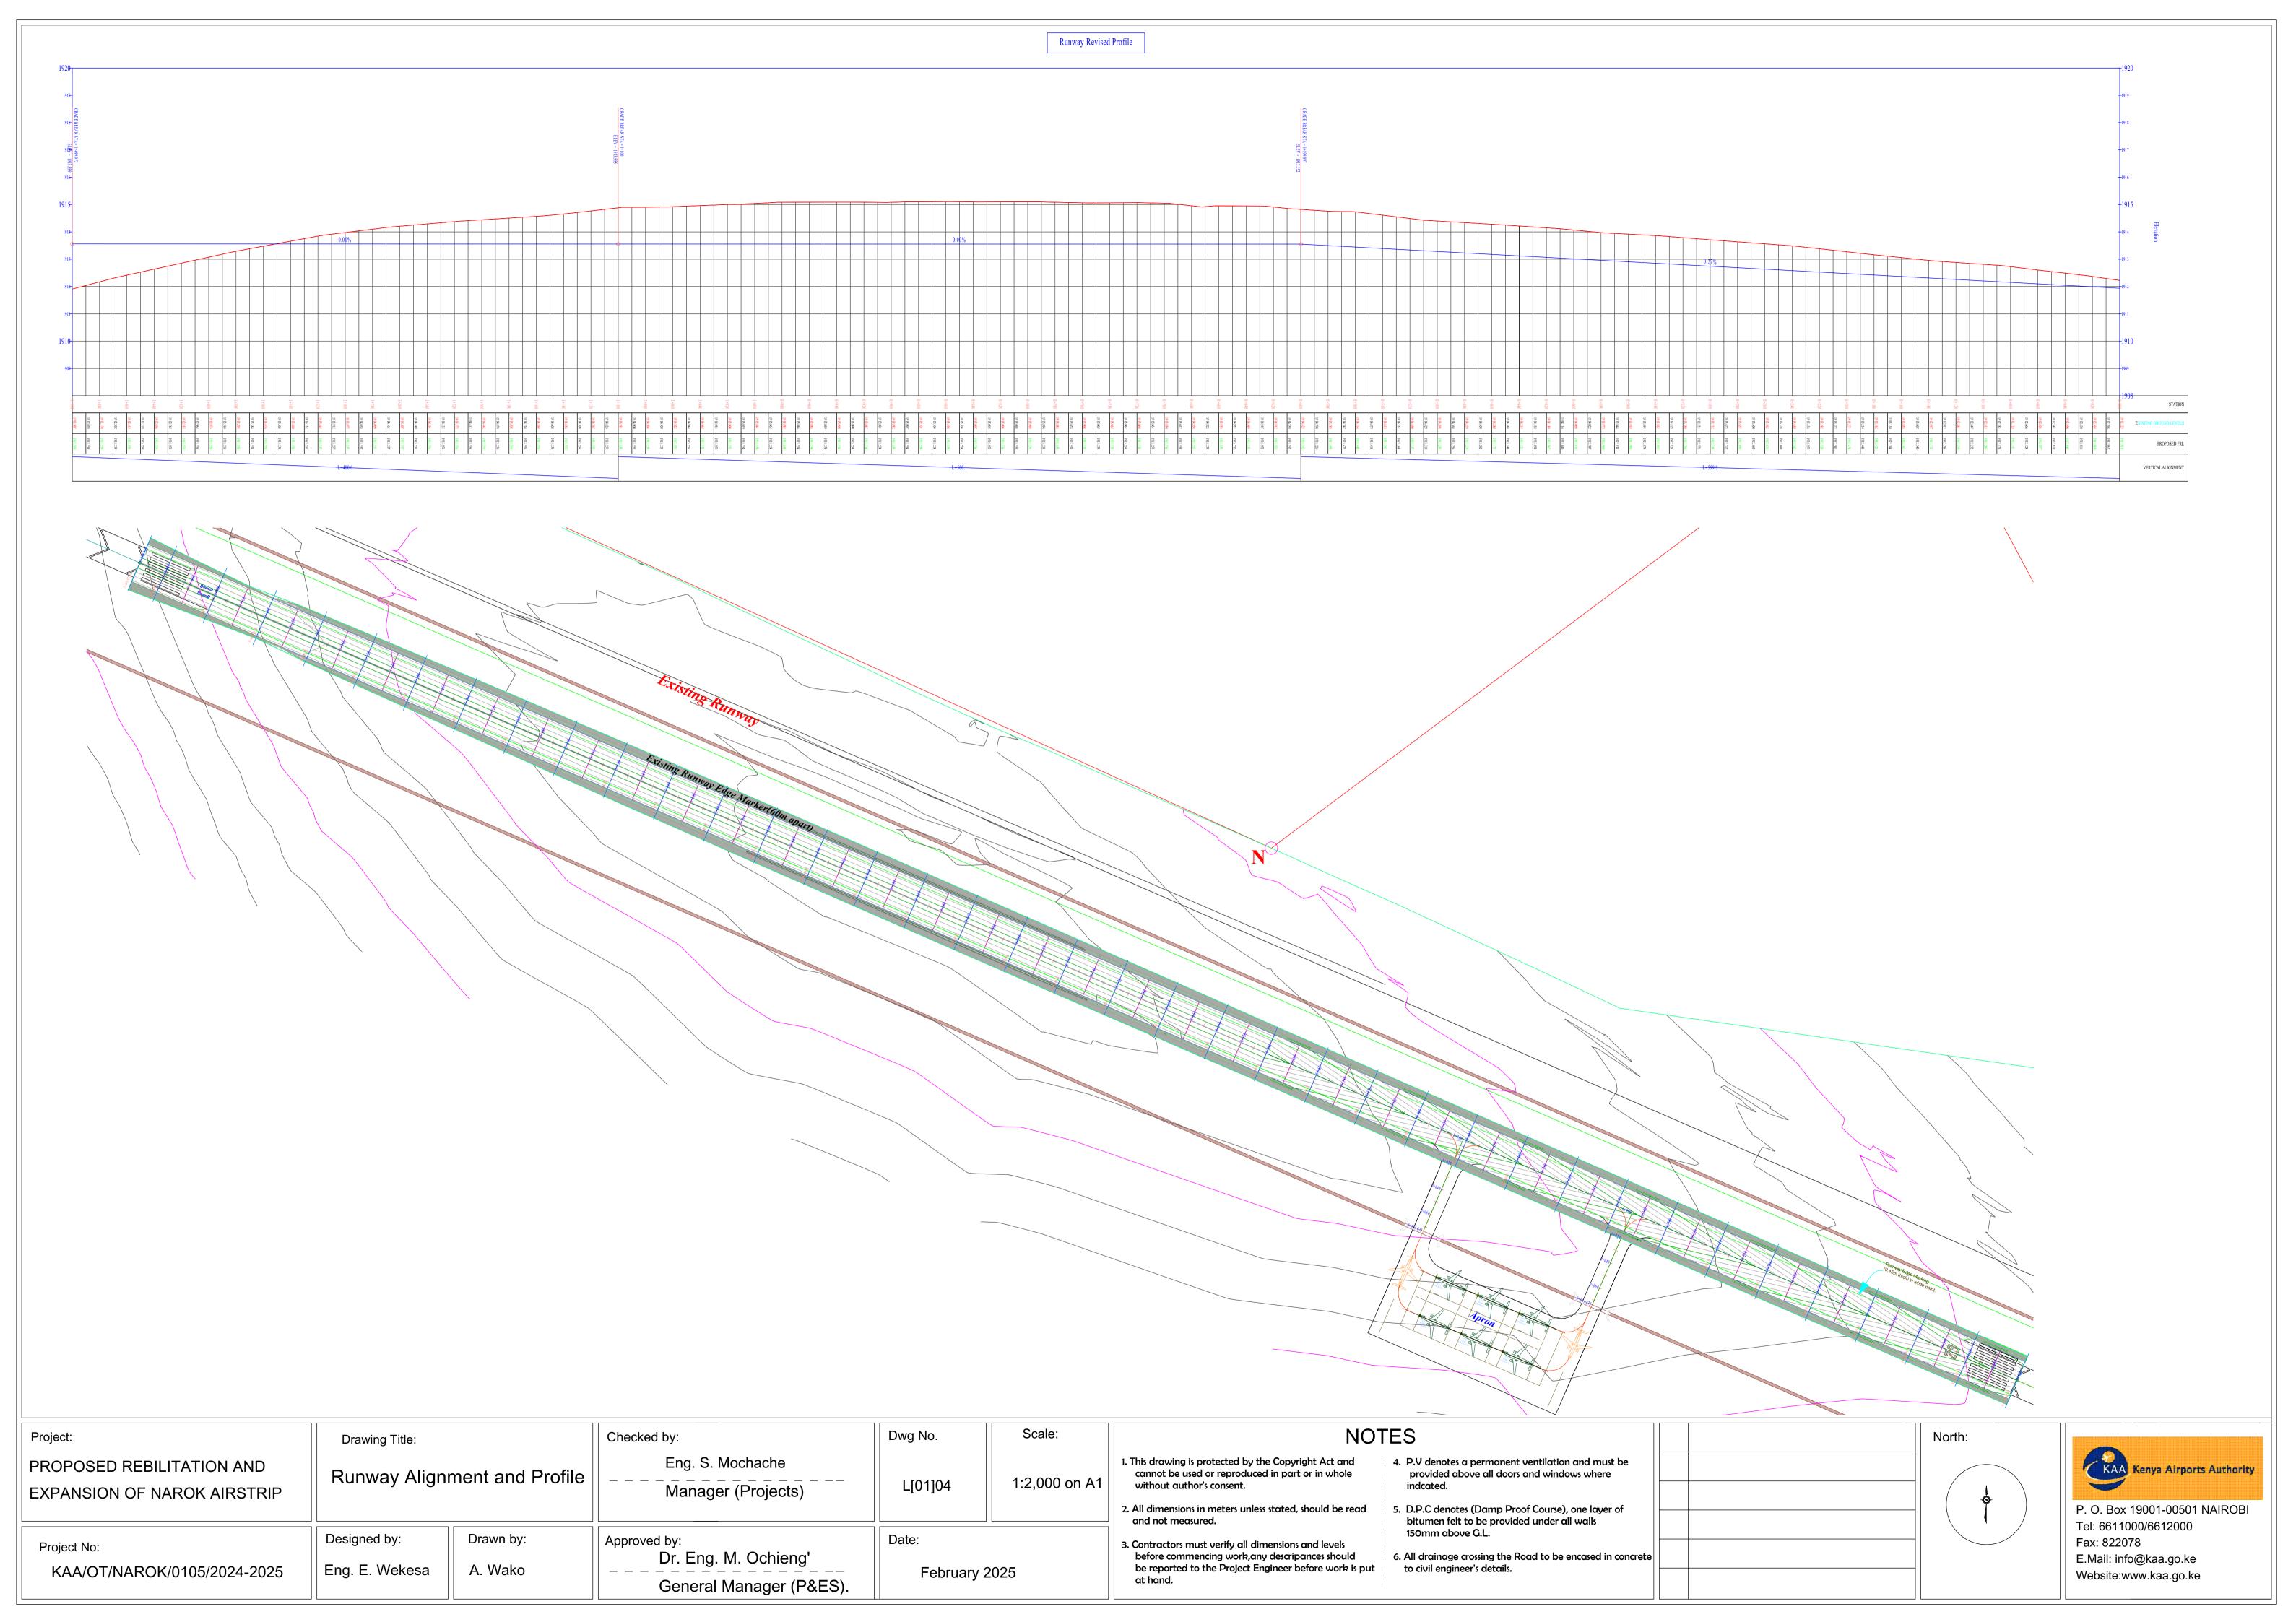



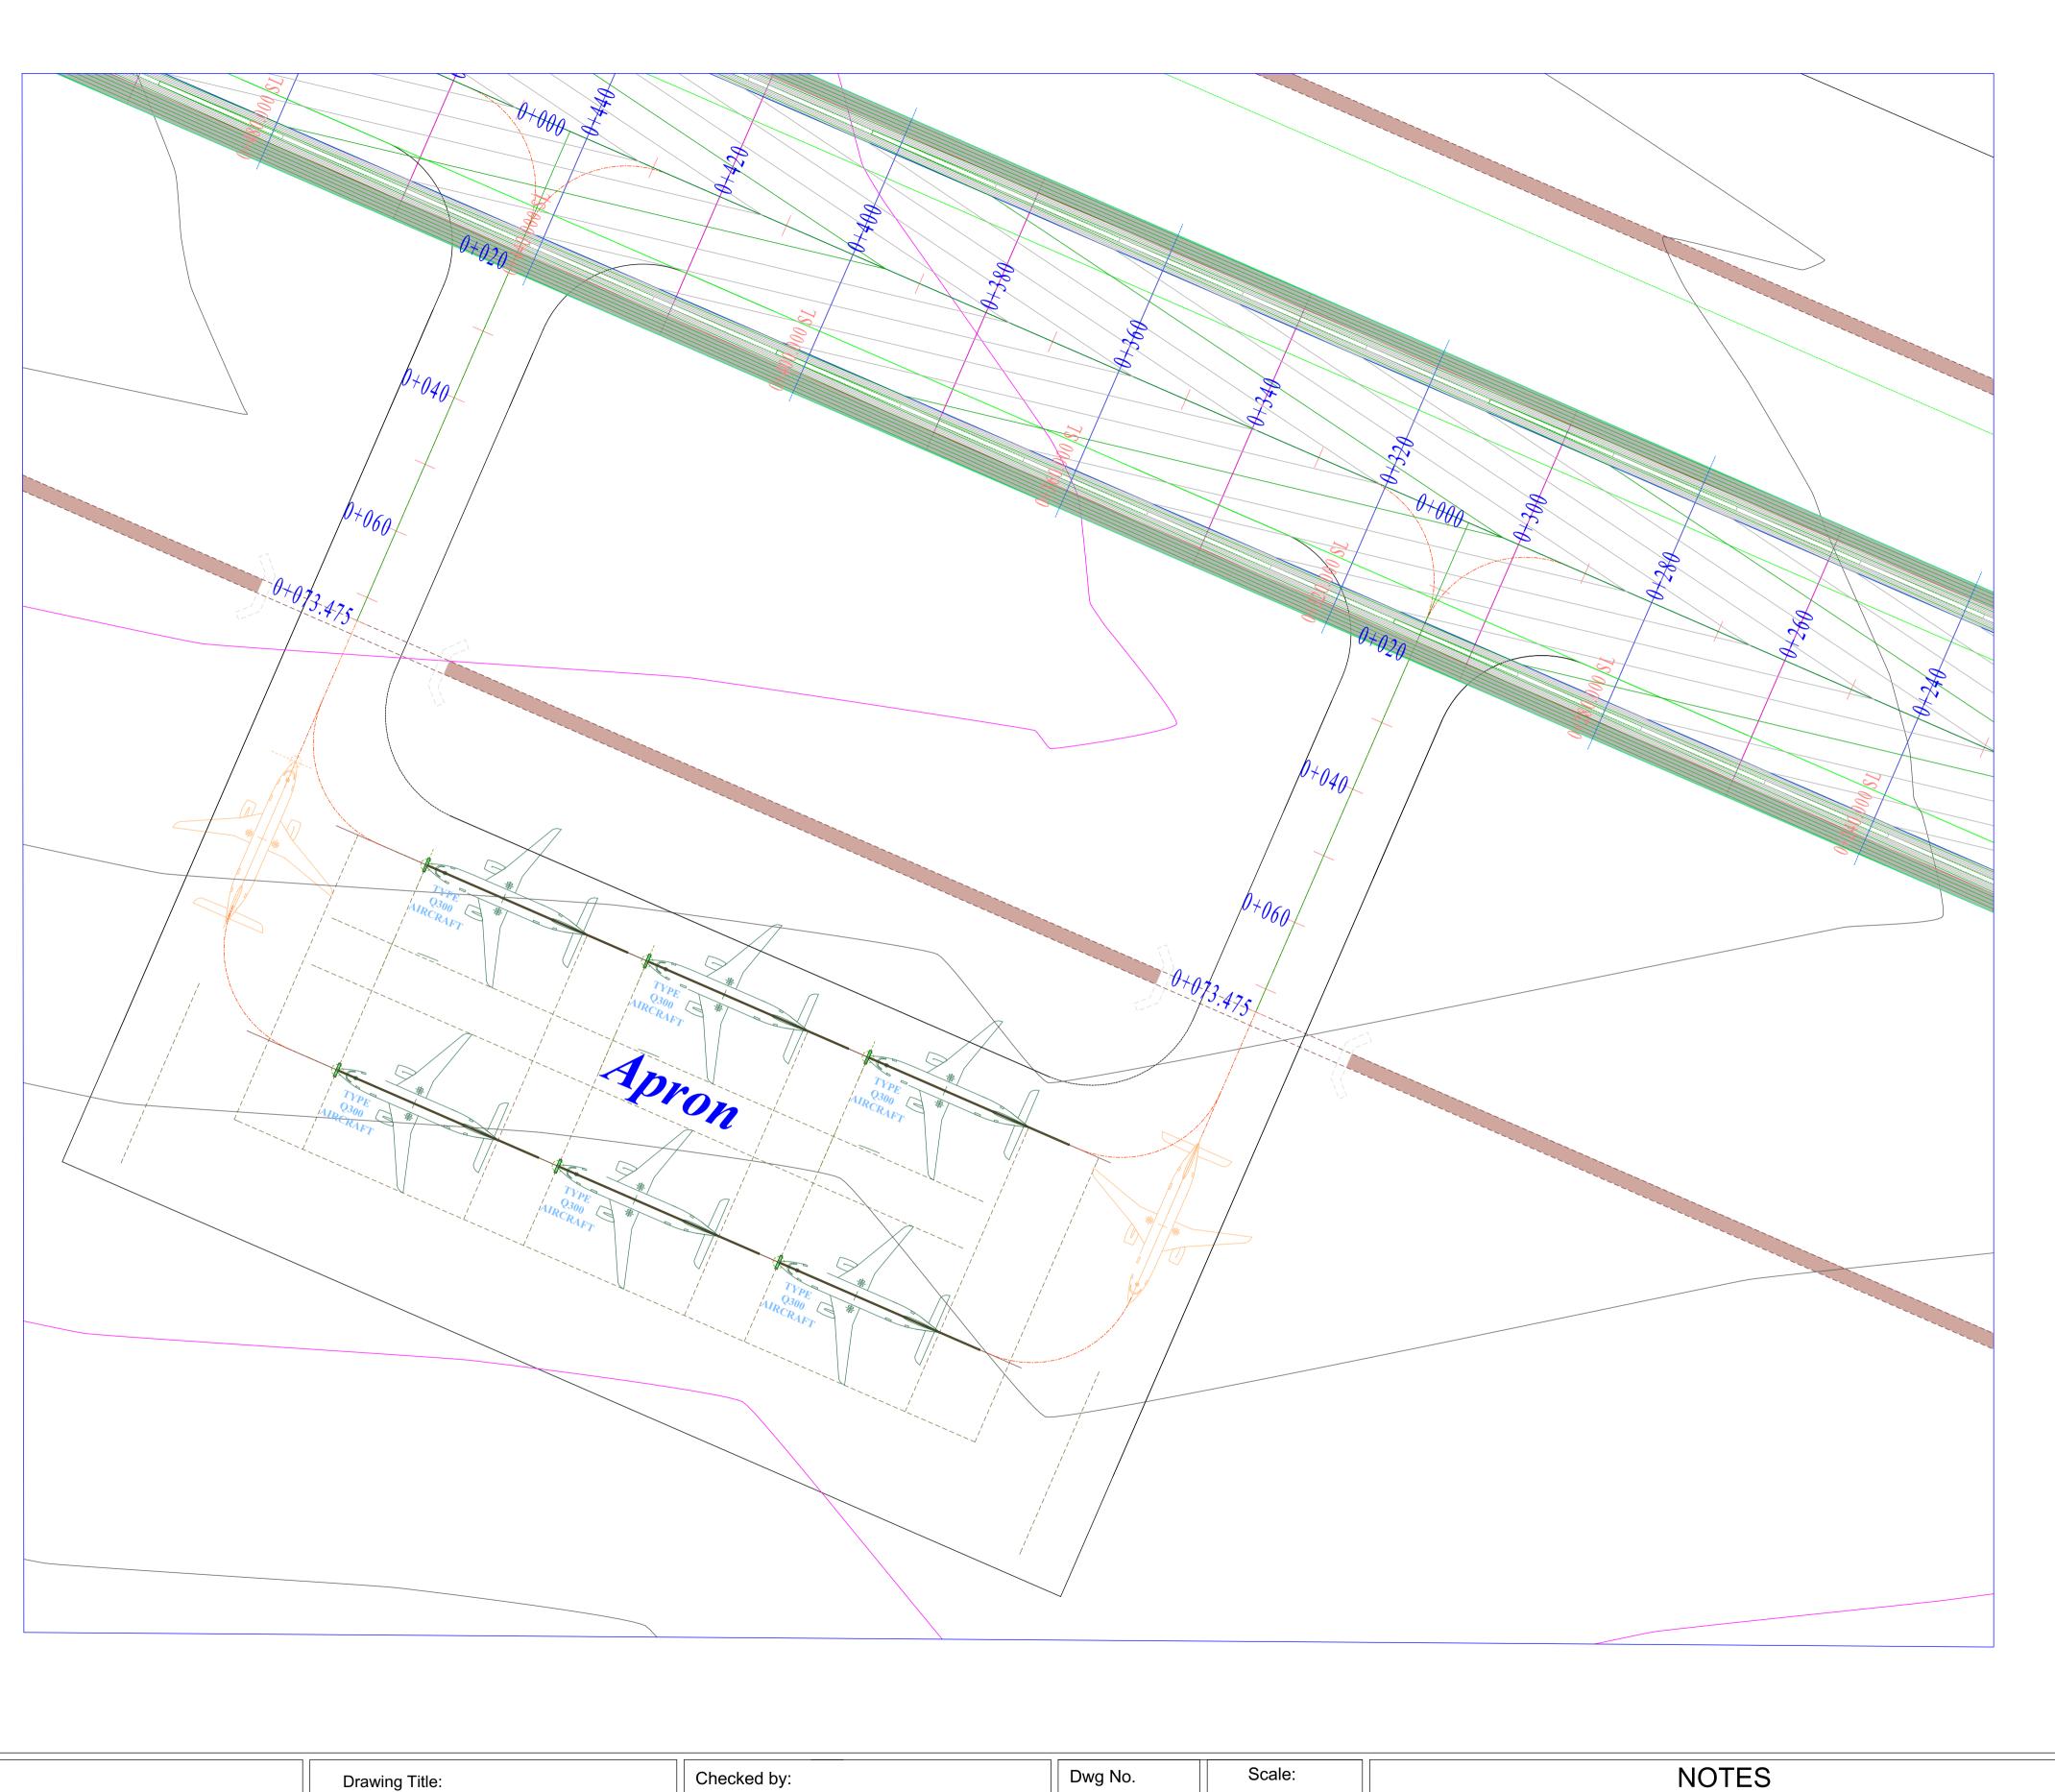

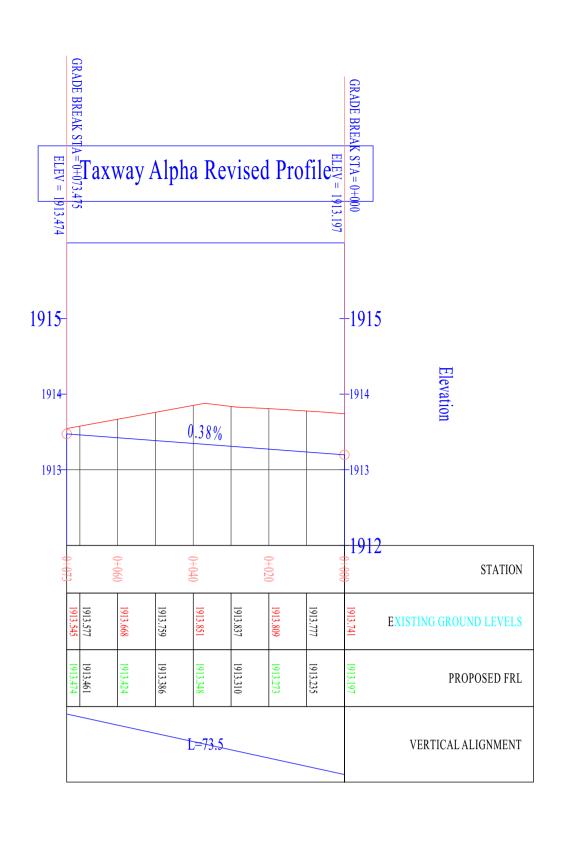

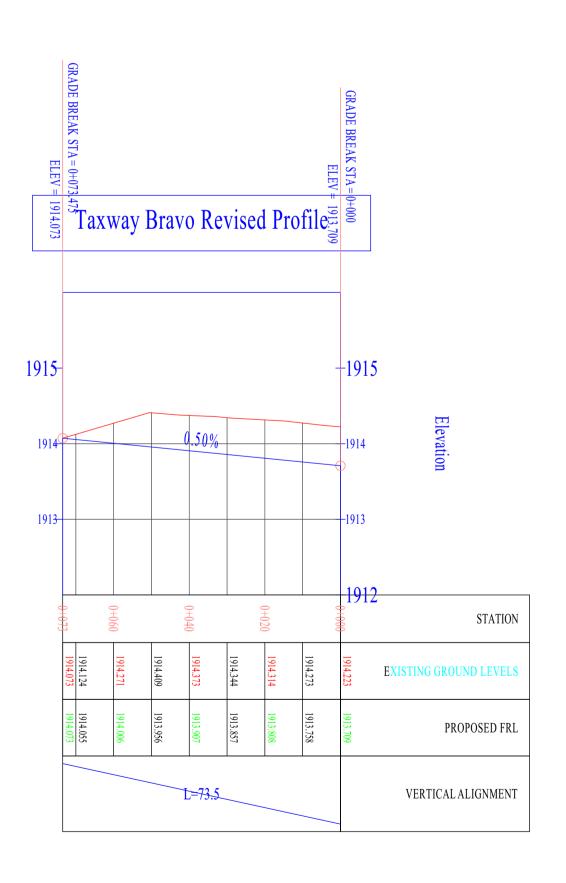

Project:	Drawing Title:		Checked by:
PROPOSED REBILITATION AND EXPANSION OF NAROK AIRSTRIP	Taxiway Align	ment and Profile	Eng. S. Mochache ————————————————————————————————————
Project No: KAA/OT/NAROK/0105/2024-2025	Designed by: Eng. E. Wekesa	Drawn by: A. Wako	Approved by: Dr. Eng. M. Ochieng' General Manager (P&ES).

	Dwg No.	Scale:
_	L[01]06	1:1,000, 1:500 on A1
	Date:	

February 2025


This drawing is protected by the Copyright Act and cannot be used or reproduced in part or in whole without author's consent.

2. All dimensions in meters unless stated, should be read and not measured.

3. Contractors must verify all dimensions and levels before commencing work, any descripances should be reported to the Project Engineer before work is put at hand.


	4. P.V denotes a permanent ventilation and must be
1	provided above all doors and windows where
1	indcated.


•	
indcated.	
5. D.P.C denotes (Damp Proof Course), one layer of	
bitumen felt to be provided under all walls 150mm above G.L.	
6. All drainage crossing the Road to be encased in concrete to civil engineer's details.	
to tivil eligilieers details.	

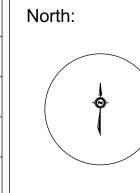



P. O. Box 19001-00501 NAIROBI Tel: 6611000/6612000 Fax: 822078 E.Mail: info@kaa.go.ke Website:www.kaa.go.ke

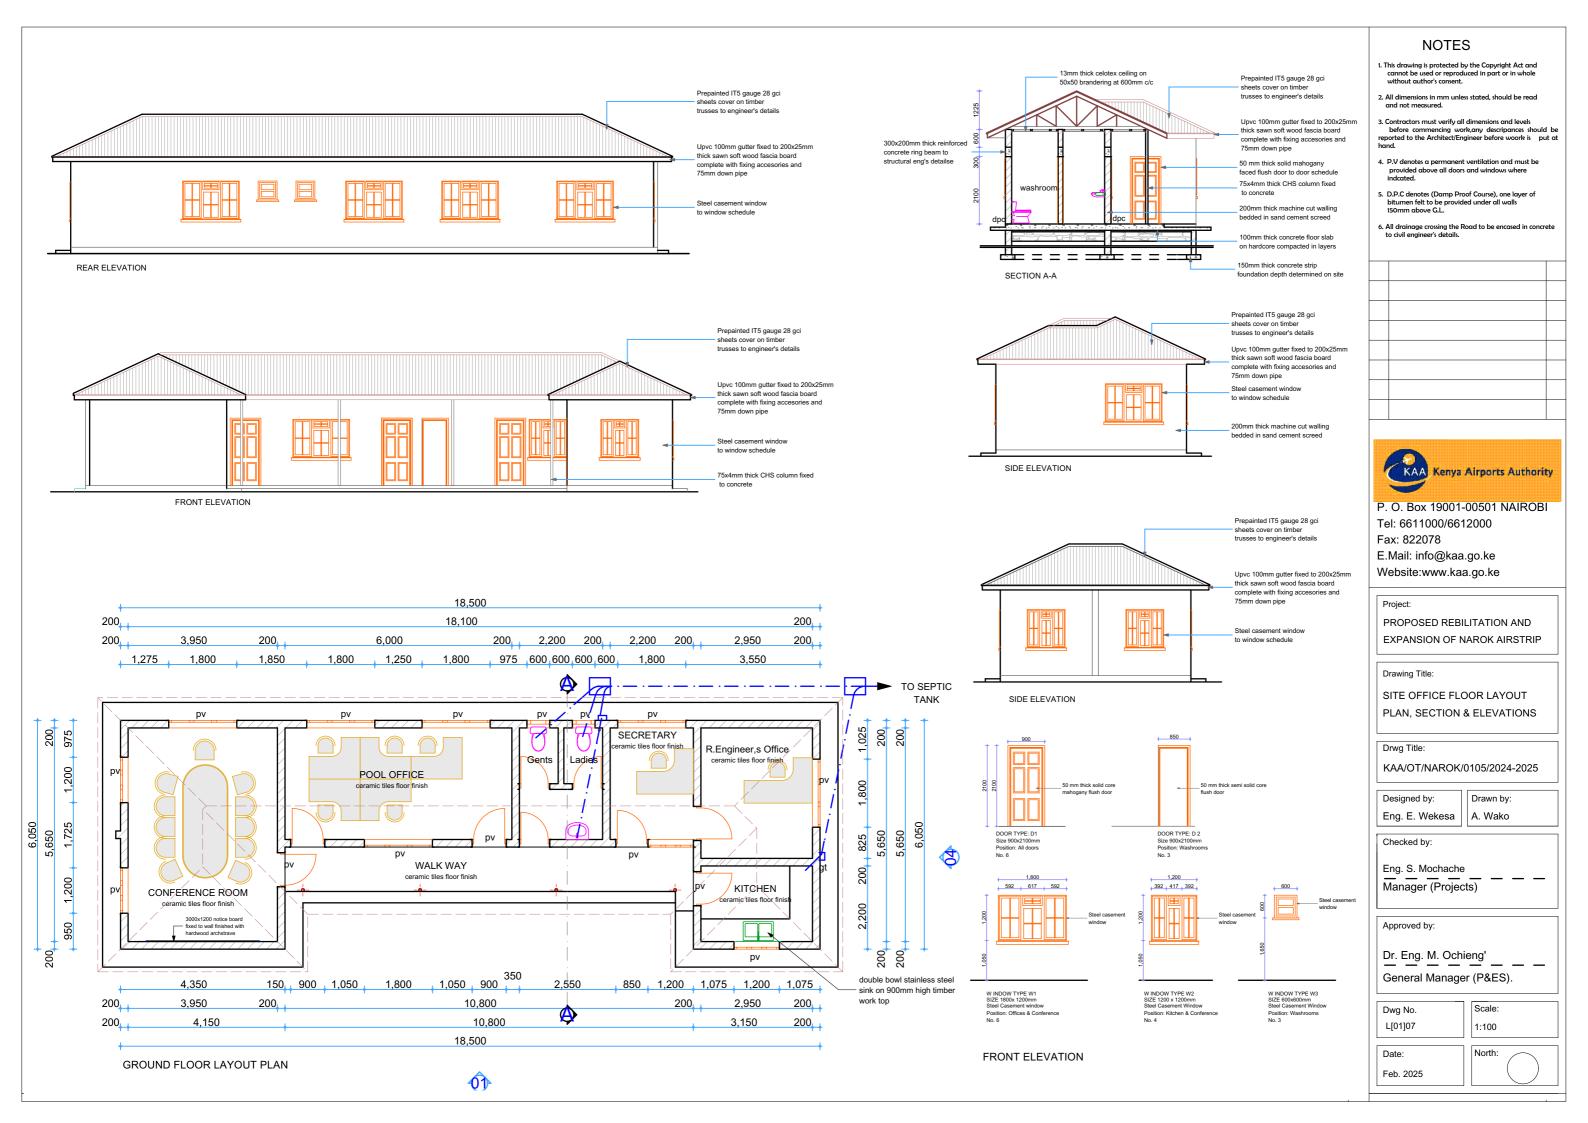

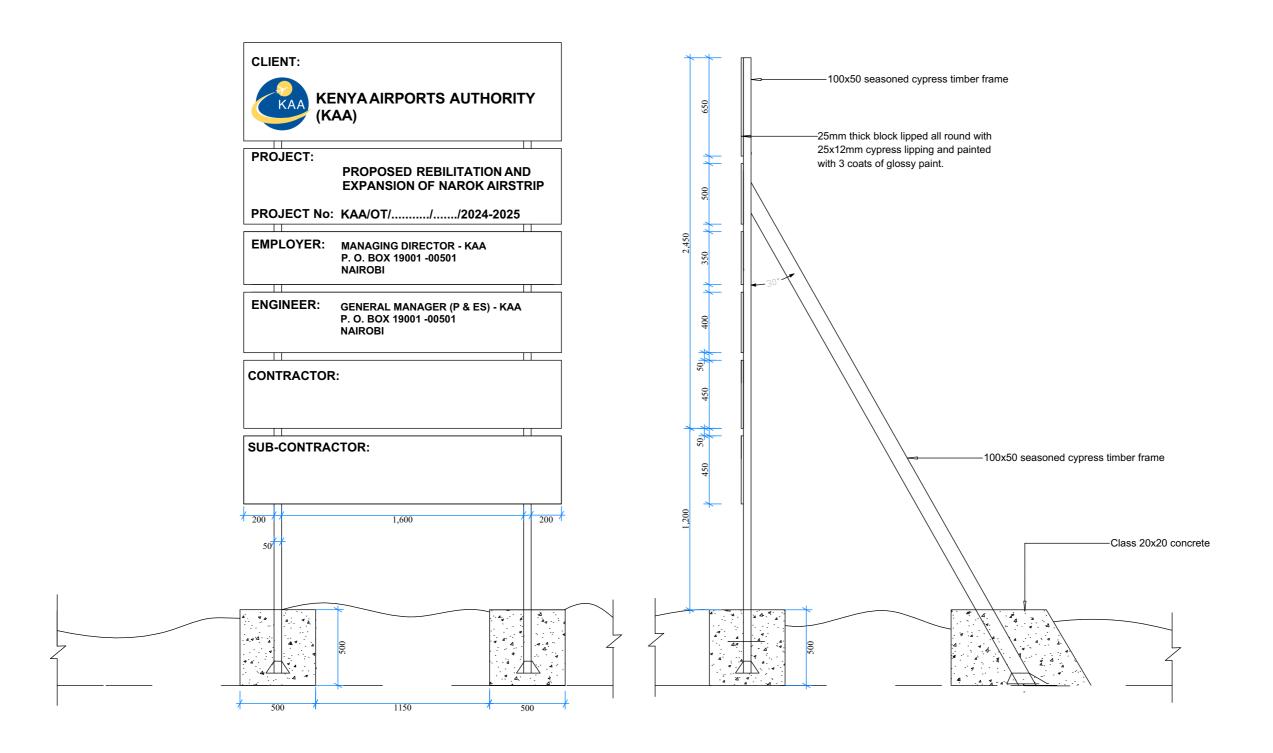

- This drawing is protected by the Copyright Act and cannot be used or reproduced in part or in whole without author's consent.
- All dimensions in meters unless stated, should be read and not measured.
- Contractors must verify all dimensions and levels before commencing work, any descripances should be reported to the Engineer before work is put at hand.
- All drainage crossing the Road to be encased in concrete to civil engineer's details.



P. O. Box 19001-00501 NAIROBI Tel: 6611000/6612000 Fax: 822078

E.Mail: info@kaa.go.ke Website:www.kaa.go.ke

Project:

PROPOSED REBILITATION AND EXPANSION OF NAROK AIRSTRIP

Drawing Title:

PROJECT SIGNBOARD

Project No.:

KAA/OT/NAROK/...../2024-2025

Drawn by: Eng. E. Wekesa A. Wako

Checked by:

Eng. S. Mochache Manager (Projects)

Approved by:


Dr.Eng. M. Ochieng'


General Manager (P&ES).

Dwg No. A[01]01

As Shown

Date: Feb. 2025

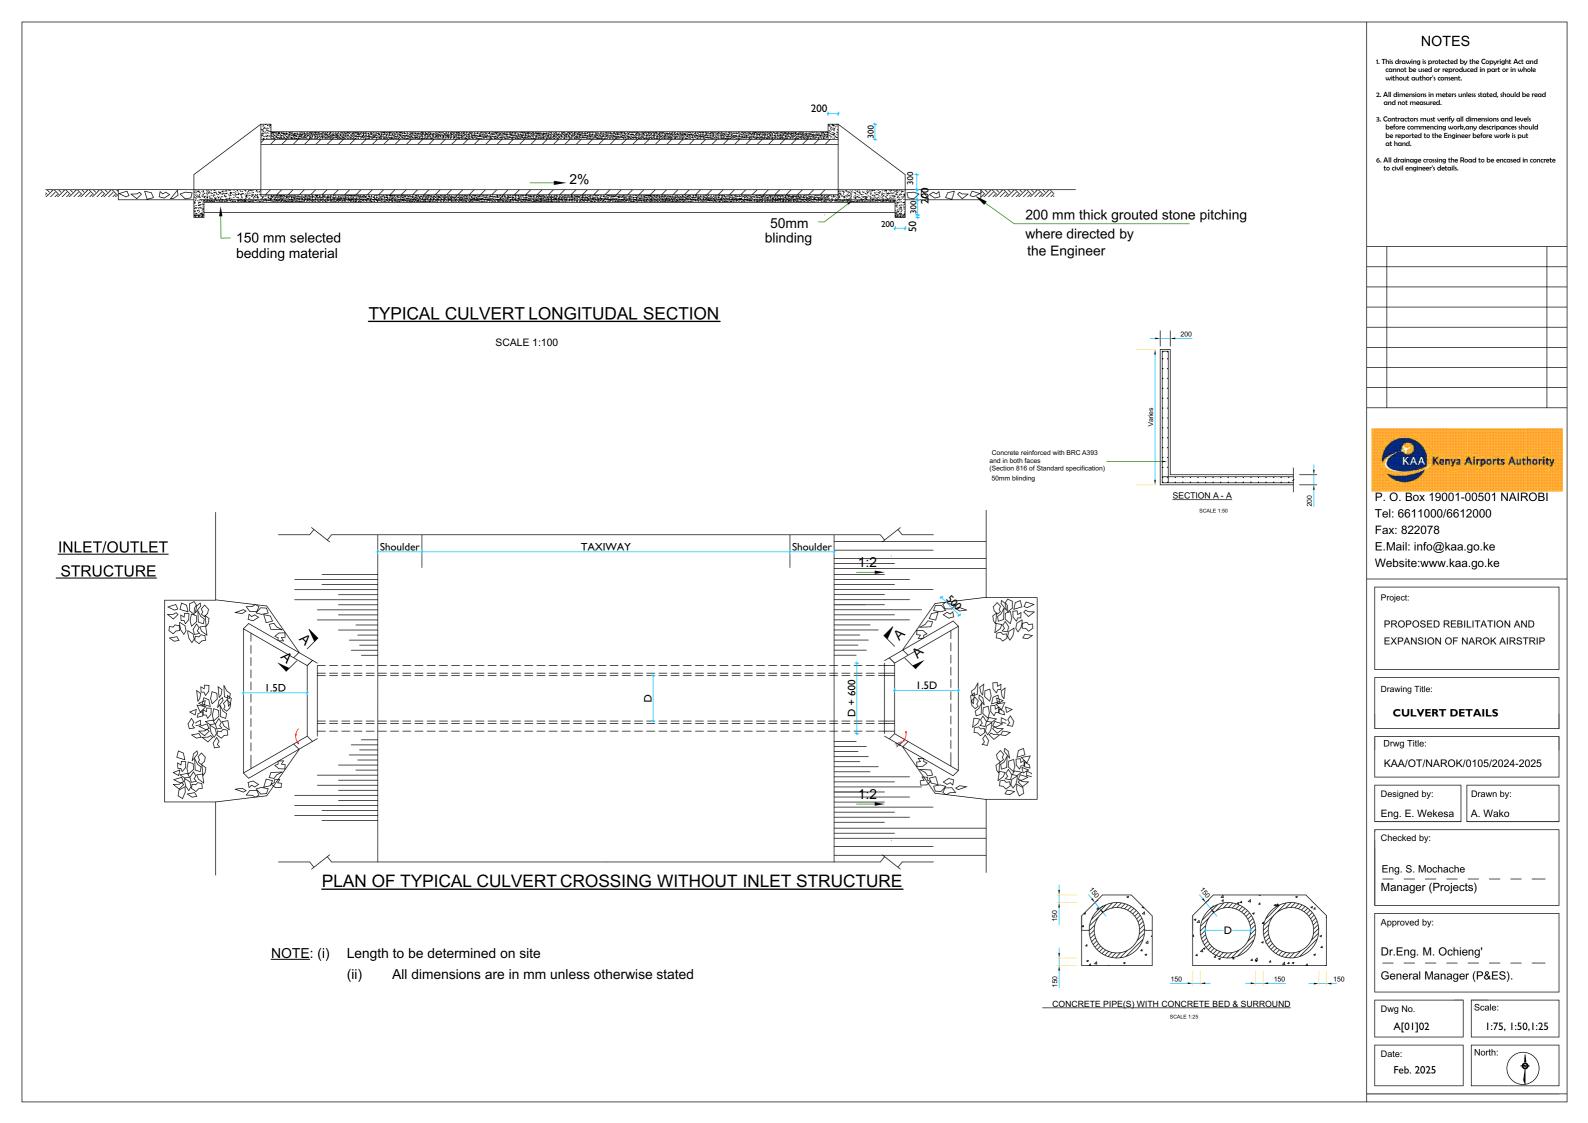

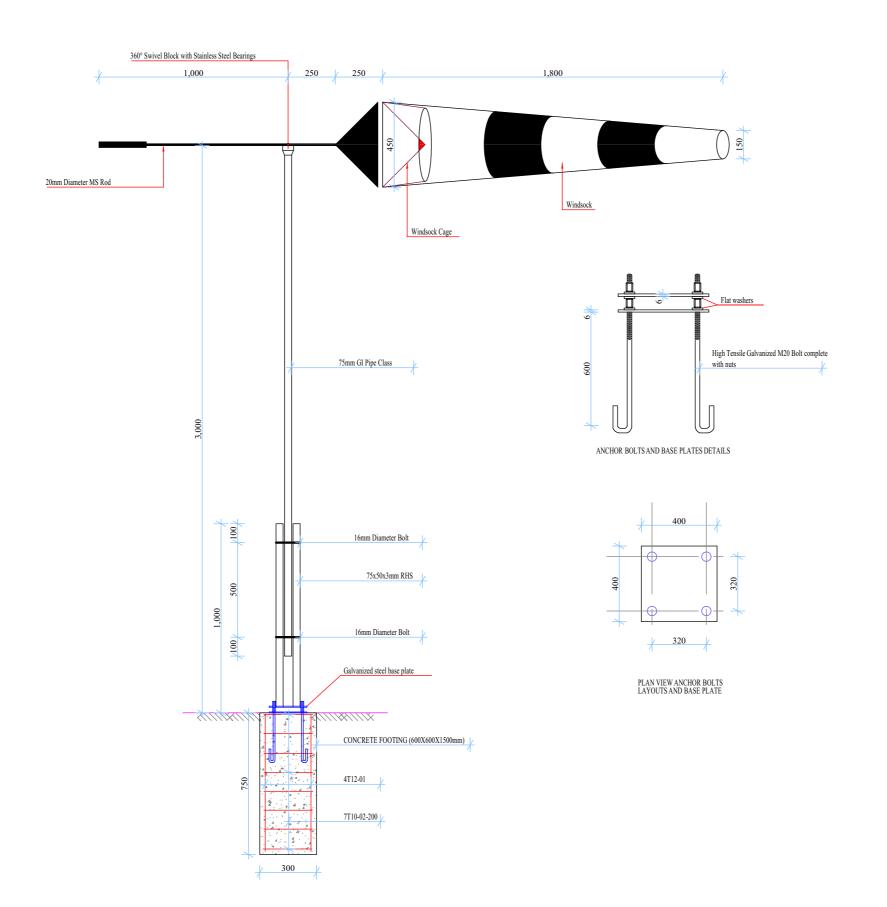

- This drawing is protected by the Copyright Act and cannot be used or reproduced in part or in whole without author's consent.
- All dimensions in meters unless stated, should be read and not measured.
- Contractors must verify all dimensions and levels before commencing work, any descripances should be reported to the Engineer before work is put at hand.
- All drainage crossing the Road to be encased in concrete to civil engineer's details.

4		

KAA Kenya Airports Authority

P. O. Box 19001-00501 NAIROBI Tel: 6611000/6612000

Fax: 822078

E.Mail: info@kaa.go.ke Website:www.kaa.go.ke

Proje

PROPOSED REBILITATION AND EXPANSION OF NAROK AIRSTRIP

Drawing Title:

WINDSOCK DETAILS

Drwg Title:

KAA/OT/NAROK/0105/2024-2025

Drawn by:

Designed by:

Eng. E. Wekesa A. Wako

Checked by:

Eng. S. Mochache

Manager (Projects)

Approved by:


Dr.Eng. M. Ochieng'


General Manager (P&ES).


Dwg No. A[01]03 Scale: 1:20 on A3


Date: Feb. 2025



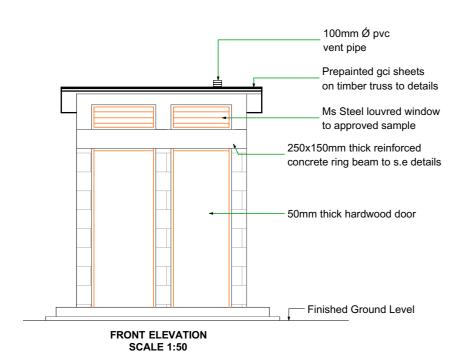


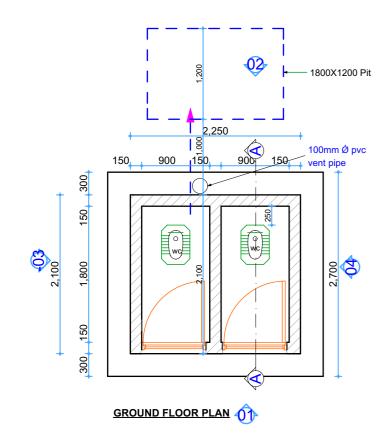

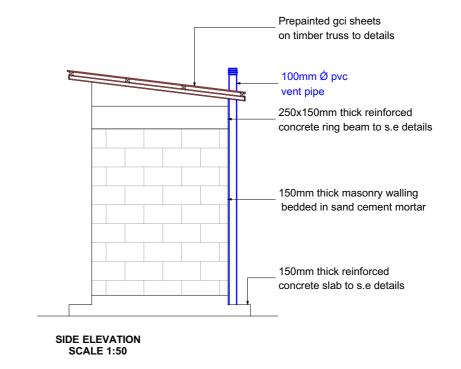

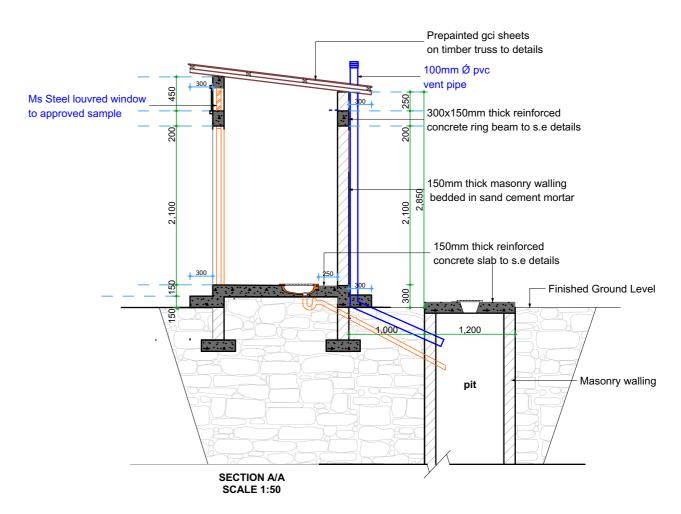

- This drawing is protected by the Copyright Act and cannot be used or reproduced in part or in whole without author's consent.
- All dimensions in meters unless stated, should be and not measured.
- Contractors must verify all dimensions and levels before commencing work, any descripances should be reported to the Project Engineer before work is put at hand.
- All drainage crossing the Road to be encased in concrete to civil engineer's details.

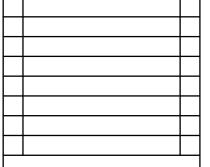



P. O. Box 19001-00501 NAIROBI

Tel: 6611000/6612000 Fax: 822078 E.Mail: info@kaa.go.ke Website:www.kaa.go.ke

Proje

PROPOSED REBILITATION AND EXPANSION OF NAROK AIRSTRIP

Drawing Title:

PROPOSED PIT LATRINE-FLOOR PLAN, SECTION & ELEVATIONS

Project No.

KAA/OT/NAROK/0105/2024-2025

Designed by:
Eng. E. Wekesa

Drawn by: A. Wako

Checked by:

Eng. S. Mochache

Manager (Projects)

Approved by:

Eng.Dr. M. Ochieng'

General Manager (P&ES).


Dwg No.


Scale: 1:50

Date: Feb. 2025


A[01]04




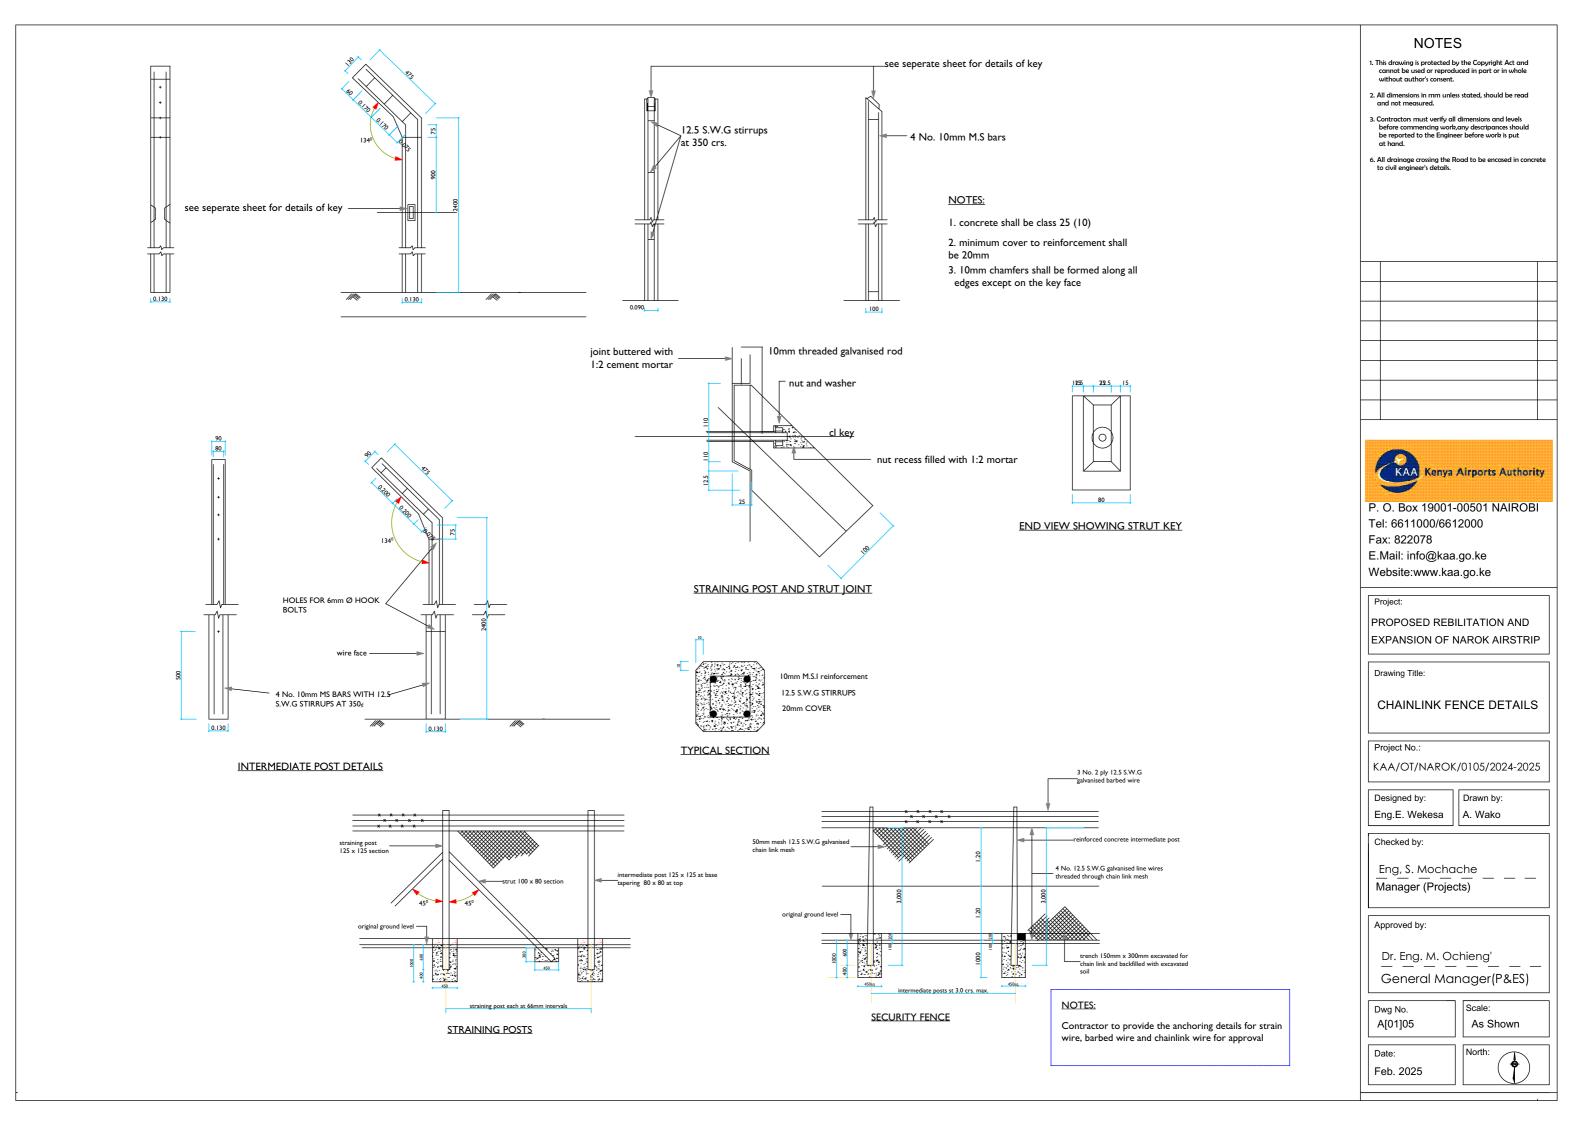

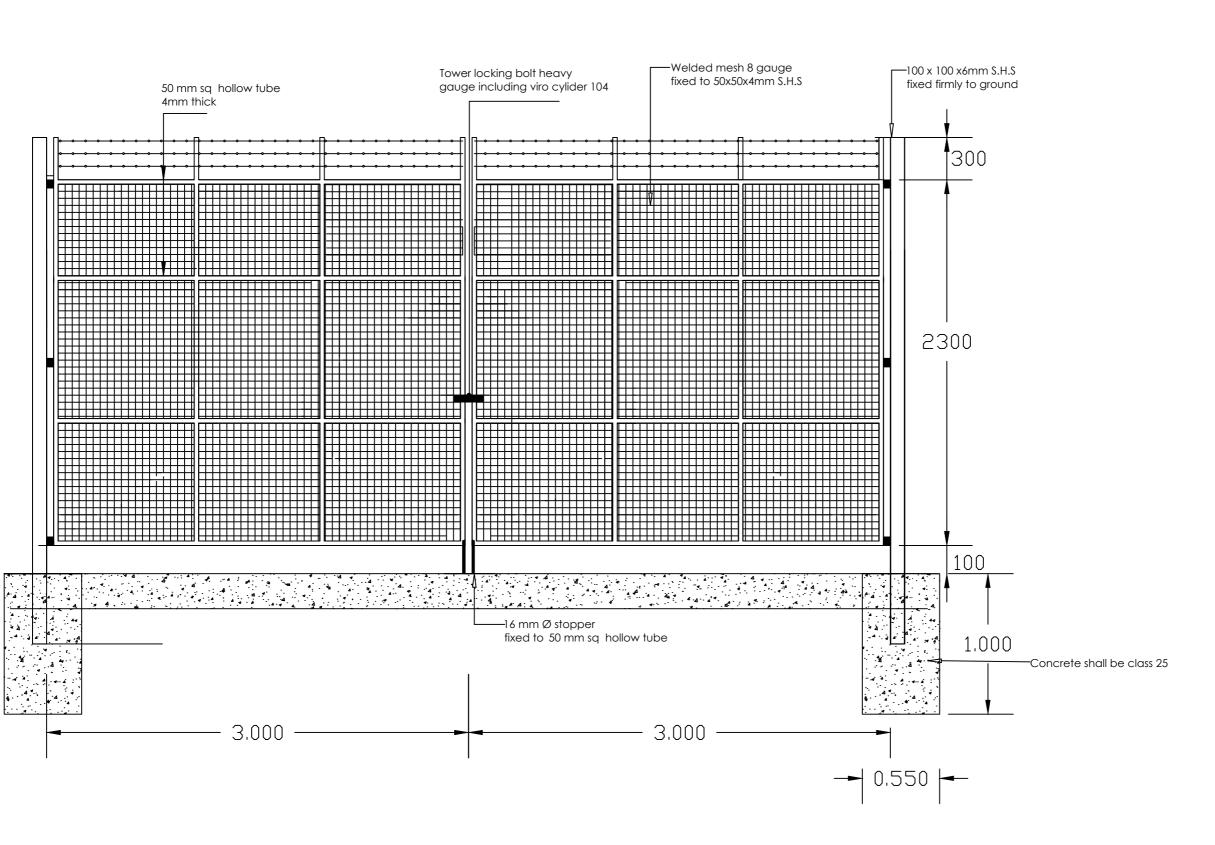

- This drawing is protected by the Copyright Act and cannot be used or reproduced in part or in whole without author's consent.
- 3. Contractors must verify all dimensions and levels before commencing work, any descripances should be reported to the Engineer before work is put at hand.
- All drainage crossing the Road to be encased in concrete
 to civil engineer's details.

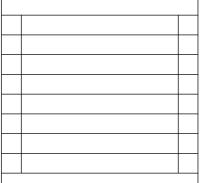

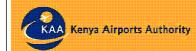

P. O. Box 19001-00501 NAIROBI Tel: 6611000/6612000 Fax: 822078 E.Mail: info@kaa.go.ke Website:www.kaa.go.ke

Project:

PROPOSED REBILITATION AND EXPANSION OF NAROK AIRSTRIP

Drawing Title:

TYPICAL CRASH GATES DETAILS

Drwg Title:

KAA/OT/NAROK/0105/2024-2025

Drawn by: Eng. E. Wekesa | A. Wako

Checked by:

Eng. S. Mochache Manager (Projects)

Approved by:

Dr.Eng. M. Ochieng'

General Manager (P&ES).


Dwg No.

A[01]06


1:100 on A3

Feb. 2025



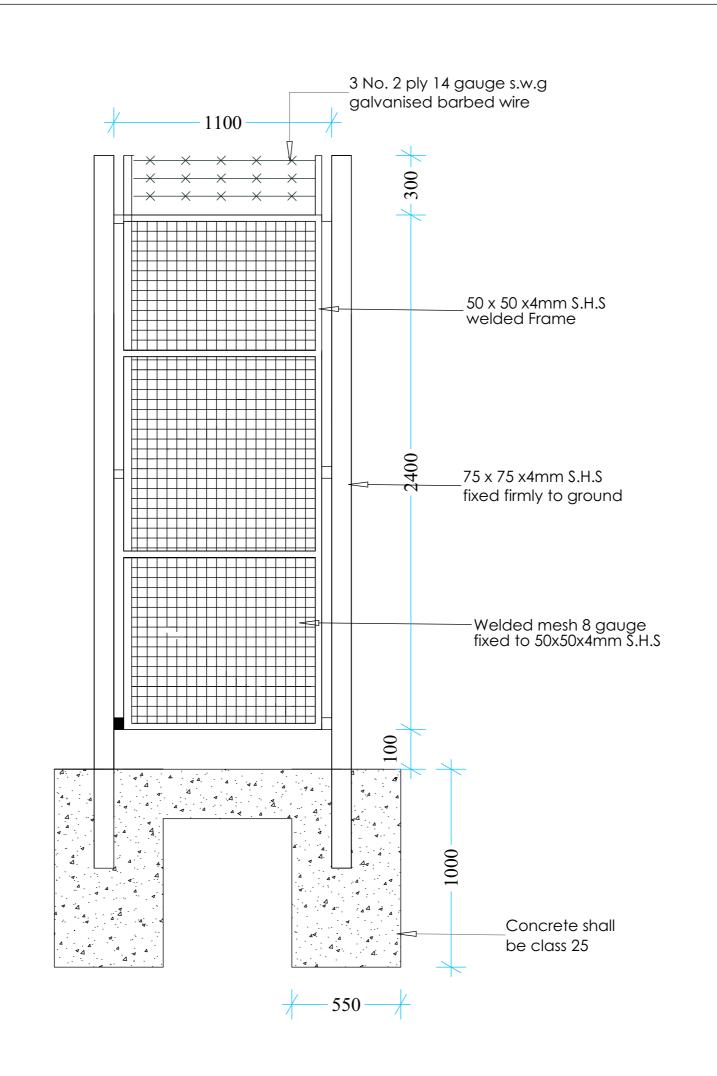

- This drawing is protected by the Copyright Act and cannot be used or reproduced in part or in whole without author's consent.
- 2. All dimensions in meters unless stated, should be read
- Contractors must verify all dimensions and levels before commencing work, any descripances should be reported to the Engineer before work is put at hand.
- All drainage crossing the Road to be encased in concrete
 to civil engineer's details.

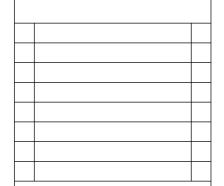



P. O. Box 19001-00501 NAIROBI Tel: 6611000/6612000

Fax: 822078

E.Mail: info@kaa.go.ke Website:www.kaa.go.ke

Project:

PROPOSED REBILITATION AND EXPANSION OF NAROK AIRSTRIP

Drawing Title:

PEDESTRIAN GATE DETAILS

Drwg Title:

KAA/OT/NAROK/0105/2024-2025

Eng. E. Wekesa A. Wako

Checked by:

Eng. S. Mochache Manager (Projects)

Approved by:

Dr.Eng. M. Ochieng'

General Manager (P&ES).

Dwg No. A[01]07

1:100 on A3

Feb. 2025




Finished Road Level 83 138 Varies (100 mm Min.)

KERB DETAILS (NTS)

NOTES

- This drawing is protected by the Copyright Act and cannot be used or reproduced in part or in whole without author's consent.
- All dimensions in meters unless stated, should be read and not measured.
- Contractors must verify all dimensions and levels before commencing work, any descripances should be reported to the Engineer before work is put at hand.
- 6. All drainage crossing the Road to be encased in concrete to civil engineer's details.

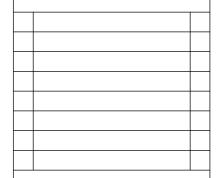



P. O. Box 19001-00501 NAIROBI Tel: 6611000/6612000

Fax: 822078
E.Mail: info@kaa.go.ke

Website:www.kaa.go.ke

Project:

PROPOSED REBILITATION AND EXPANSION OF NAROK AIRSTRIP

Drawing Title:

ROAD KELB DETAILS

Drwg Title:

KAA/OT/NAROK/0105/2024-2025

Designed by:

Eng. E. Wekesa A. Wako

/\.

Drawn by:

Checked by:

Eng. S. Mochache
Manager (Projects)

Approved by:

Dr.Eng. M. Ochieng'

General Manager (P&ES).

Dwg No. A[01]08

Date:

Scale: 1:20

